
AMENDED DA CLAUSE 4.55 PROPOSED TWO STOREY ATTACHED DUPLEX 11 HARDEN CRS GEORGES HALL

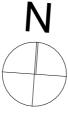

	DA DRAWING LIST		
Plan Number	Drawing Name	ISSUE	
1	COVER PAGE	F	
2	APPROVED AND REVISED 1ST FLOOR PL	F	
3	APPROVED AND REVISED ELEVATIONS	F	
4	APPROVED AND REVISED ELEVATIONS	F	
5	APPROVED AND REVISED ELEVATIONS	F	
6	APPROVED AND REVISED ELEVATIONS	F	
7	APPROVED AND REVISED SECTIONS	F	
8	APPROVED AND REVISED SECTIONS	F	
9	APPROVED AND REVISED SECTIONS	F	
10	APPROVED AND REVISED FRONT FENCE	F	
11	SITE ANALYSIS	F	
12	DEMOLITION PLAN	F	
13	SUBDIVISION PLAN	F	
14	SEDIMENT CONTROL PLAN	F	
15	SITE PLAN	F	
16	DRIVEWAY PROFILES	F	
17	GROUND FLOOR PLAN	F	
18	FIRST FLOOR PLAN	F	
19	ROOF PLAN	F	
20	ELEVATIONS	F	
21	ELEVATIONS	F	
22	SECTIONS	F	
23	SECTION	F	
24	CONCEPT LANDSCAPE PLAN	F	
25	WINDOWS AND DOORS SCHEDULE	F	
26	BASIX COMMITMENTS	F	
27	STREETSCAPE & FENCE DETAIL	F	
28	SHADOW DIAGRAMS		

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I project

Mr HAYDAR ALI

PROPOSED ATTACHED DUAL

OCCUPANCY AMENDED DA CLAUSE 4.55 Sheet Title: COVER PAGE


11 HARDEN CRES GEORGES

HALL LOT 22 DP236764

Scale	1:1		Date/Revision 05/01/2
ssue	F	Drawing No.: 11 hardencres	Sheet Number:

CLAUSE 4.55 AMENDMENTS

- 1. LOWER ROOF TO ALFRESCO CHANGE TO METAL ROOF WITH GABLE
- 2. MASTER BEDROOM ENSUITE REVISED LAYOUT AND SIZE, WINDOW RELOCATED
- 3. BATHROOMS REVISED LAYOUT, WINDOW RELOCATED
- 4. FRONT 1ST FLOOR BALCONY PROFILE AMENDED TO SUIT FACADE CHARACTER

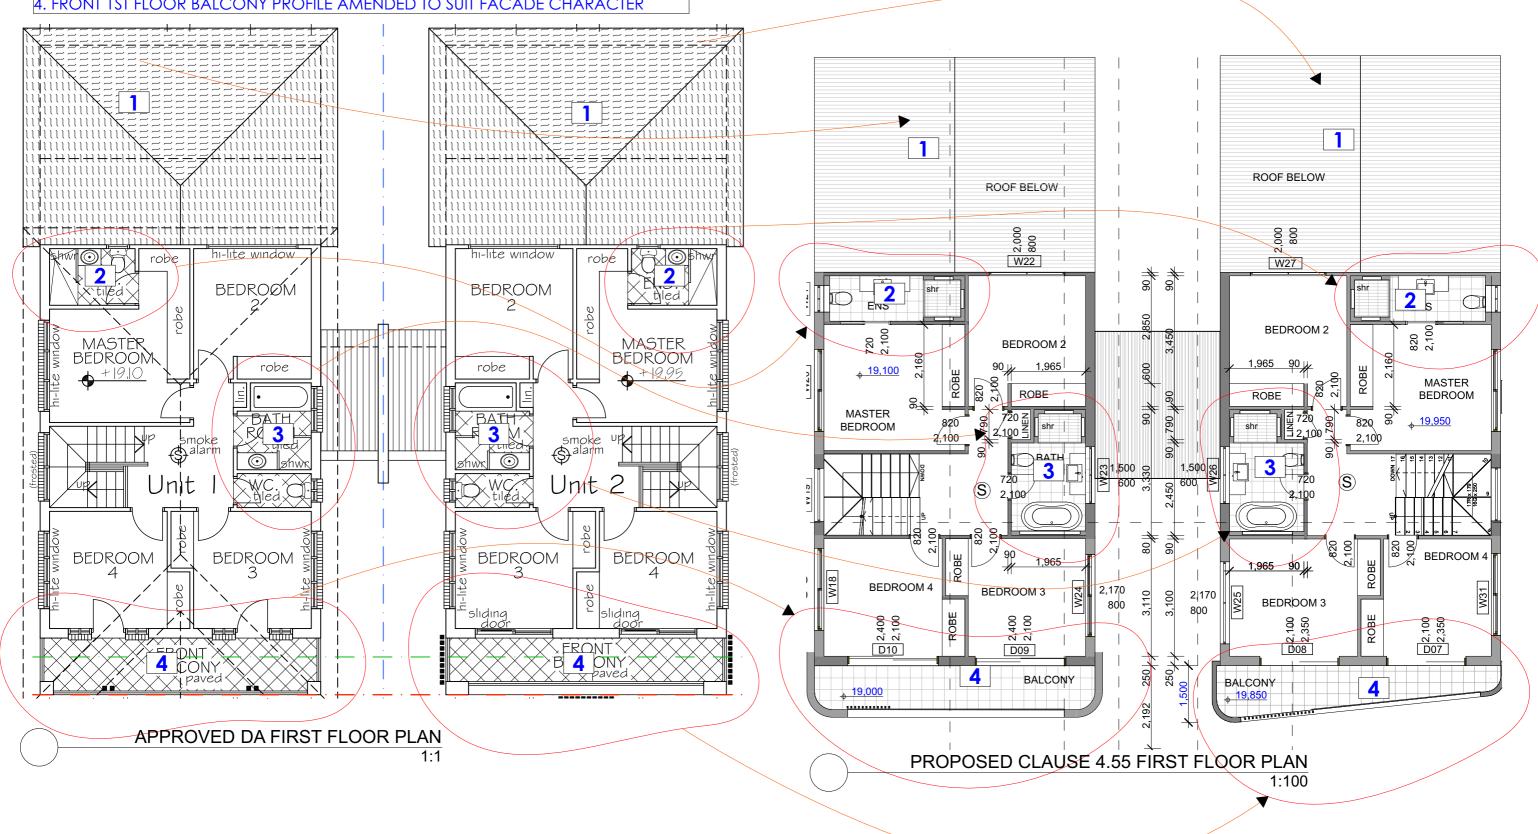

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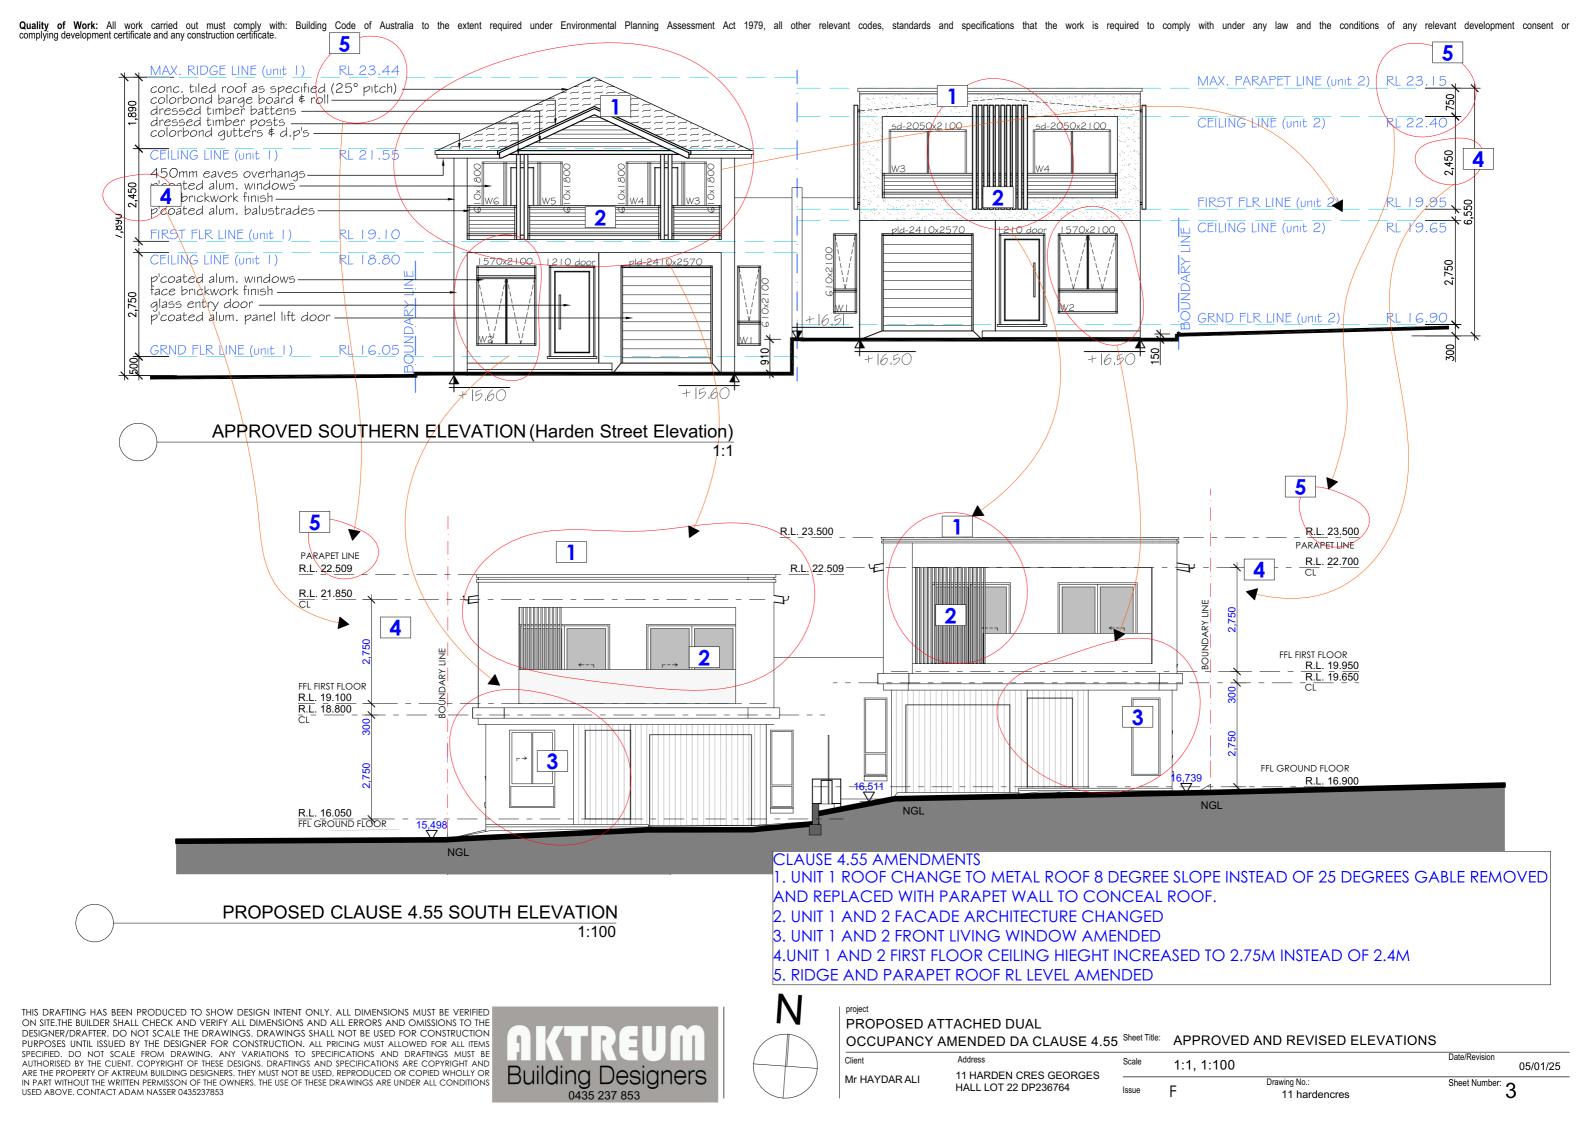




PROPOSED ATTACHED DUAL APPROVED AND REVISED 1ST FLOOR PLAN OCCUPANCY AMENDED DA CLAUSE 4.55 Sheet Title: Client

11 HARDEN CRES GEORGES Mr HAYDAR ALI HALL LOT 22 DP236764

1:1, 1:100 Sheet Number: 2 Drawing No. 11 hardencres



Quality of Work: All work carried out must comply with: Building Code of Australia to the extent required under Environmental Planning Assessment Act 1979, all other relevant codes, standards and specifications that the work is required to comply with under any law and the conditions of any relevant development consent or complying development certificate and any construction certificate. metal sheet roofing (5° pitch) colorbond barge board \$ roll-MAX. RIDGE LINE (unit 1) RL 23.44 MAX. PARAPET LINE (unit 2) RL 23.15 4 4 EILING LINE (unit 2) RL 22.40 450mm eaves overhangs-2 p' 5 pd alum. windows fa 5 lickwork finish— CEILING LINE (unit 1) RL 21.55 2 conc. tiled roof as specified (20° pitch) colorbond gutters & d.p's 5 ,450 FIRST FLR LINE (unit 2) RL 19.95 3 3 RL 19.65 CEILING LINE (unit 2) FIRST FLR LINE (unit 1) RL 19.10 450mm eaves overhangs. CEILING LINE (unit 1) RL 18.80 p'coated alum. windows face brickwork finish p'coated alum. sliding door GRND FLR LINE (unit 2) RL 16.90 6 6 GRND FLR LWE (unit 1) RL 16.05 + 16,44 +16,44 APPROVED NORTH ELEVATION 4 8° Roof slope Metal Gutter & Fascia 6 R.L. 23.500 R.L. 23.500 8^o Roof slope PARAPET RIDGE LINE 4 Metal Gutter & Fascia R.L. 22.700 R.L. 22.509 R.L. 22.509 RIDGE LINE 5 R.L. 21.850 2 ¥ 5 FFL FIRST FLOOR R.L. 19.950 R.L. 19.650 3 FFI FIRST FI OOR R.L. 19.100 R.L. 18.800 6 6 FFI GROUND FLOO R.I. 16.900 R.L. 16.050 FFL GROUND FLOOR NGL **CLAUSE 4.55 AMENDMENTS** 1. UNIT 1 AND 2 ENSUITE WINDOW RELOCATED FROM REAR WALL TO SIDE WALL 2. UNIT 1 AND 2 BEDROOM 2 REAR WINDOW WIDTH REDUCED PROPOSED CLAUSE 4.55 NORTH ELEVATION 3. UNIT 1 AND 2 ALFRESCO ROOF CHANGED TO GABLE ROOF AND METAL CLADDING 4.UNIT 1 AND 2 FIRST FLOOR ROOF LOWERED SLOPE TO 8 DEGREES AND MADE GABLE END 1:100 5. UNIT 1 AND 2 FIRST FLOOR CEILING HIEGHT INCREASED TO 2.75M INSTEAD OF 2.4M

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LISED ABOVE CONTACT ADAM NASSER 0435237853






6. RIDGE PARAPET RL LEVEL AMENDED

PROPOSED ATTACHED DUAL
OCCUPANCY AMENDED DA CLAUSE 4.55 Sheet Title: APPROVED AND REVISED ELEVATIONS

Scale 1:1, 1:100 Date/Revision 05/01/25

Issue F 11 hardencres Sheet Number: 4

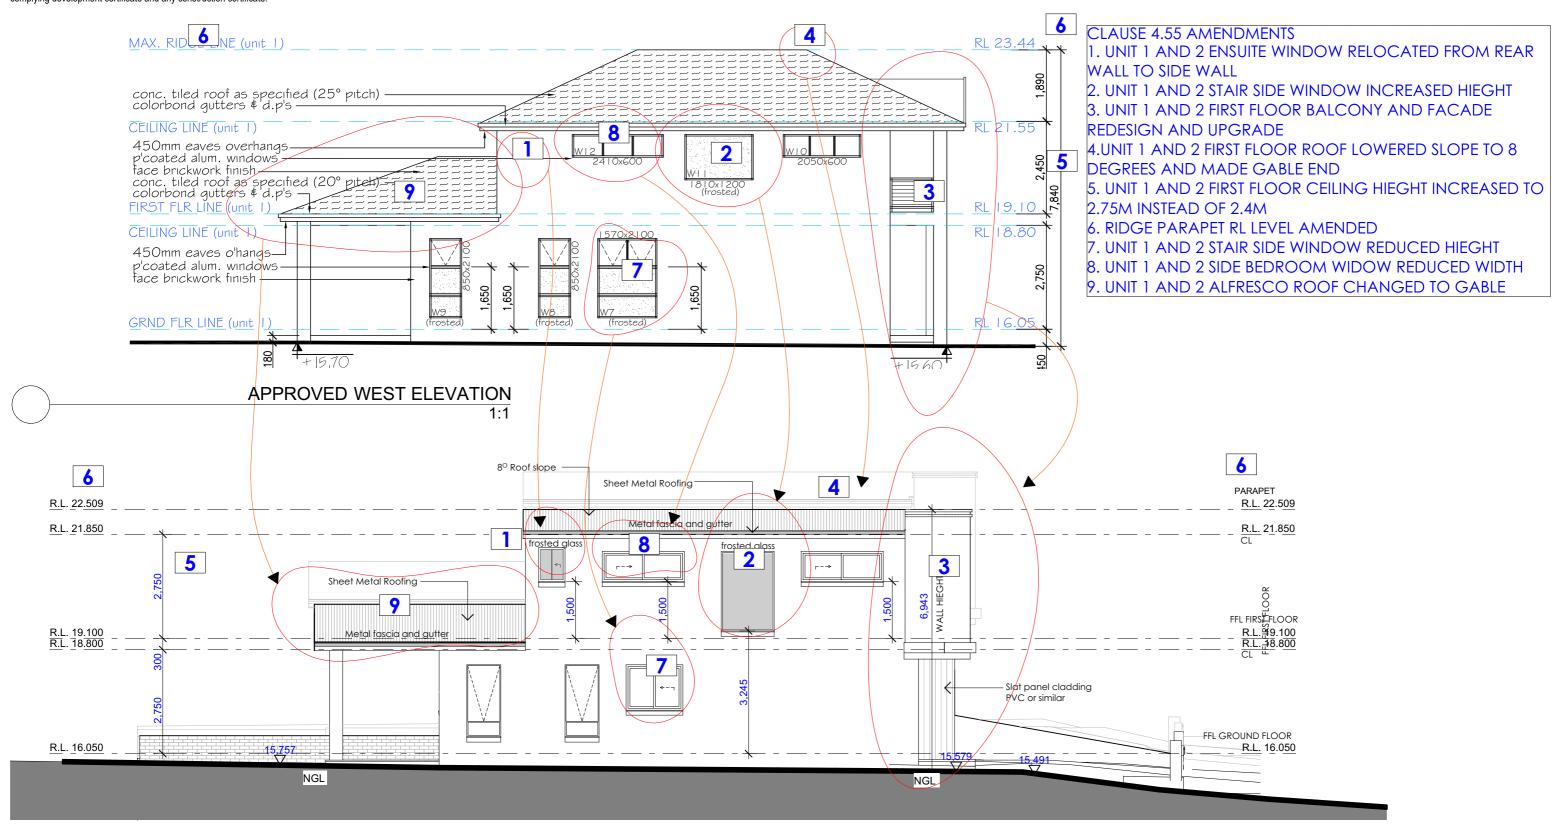

PROPOSED CLAUSE 4.55 WEST ELEVATION
1:100

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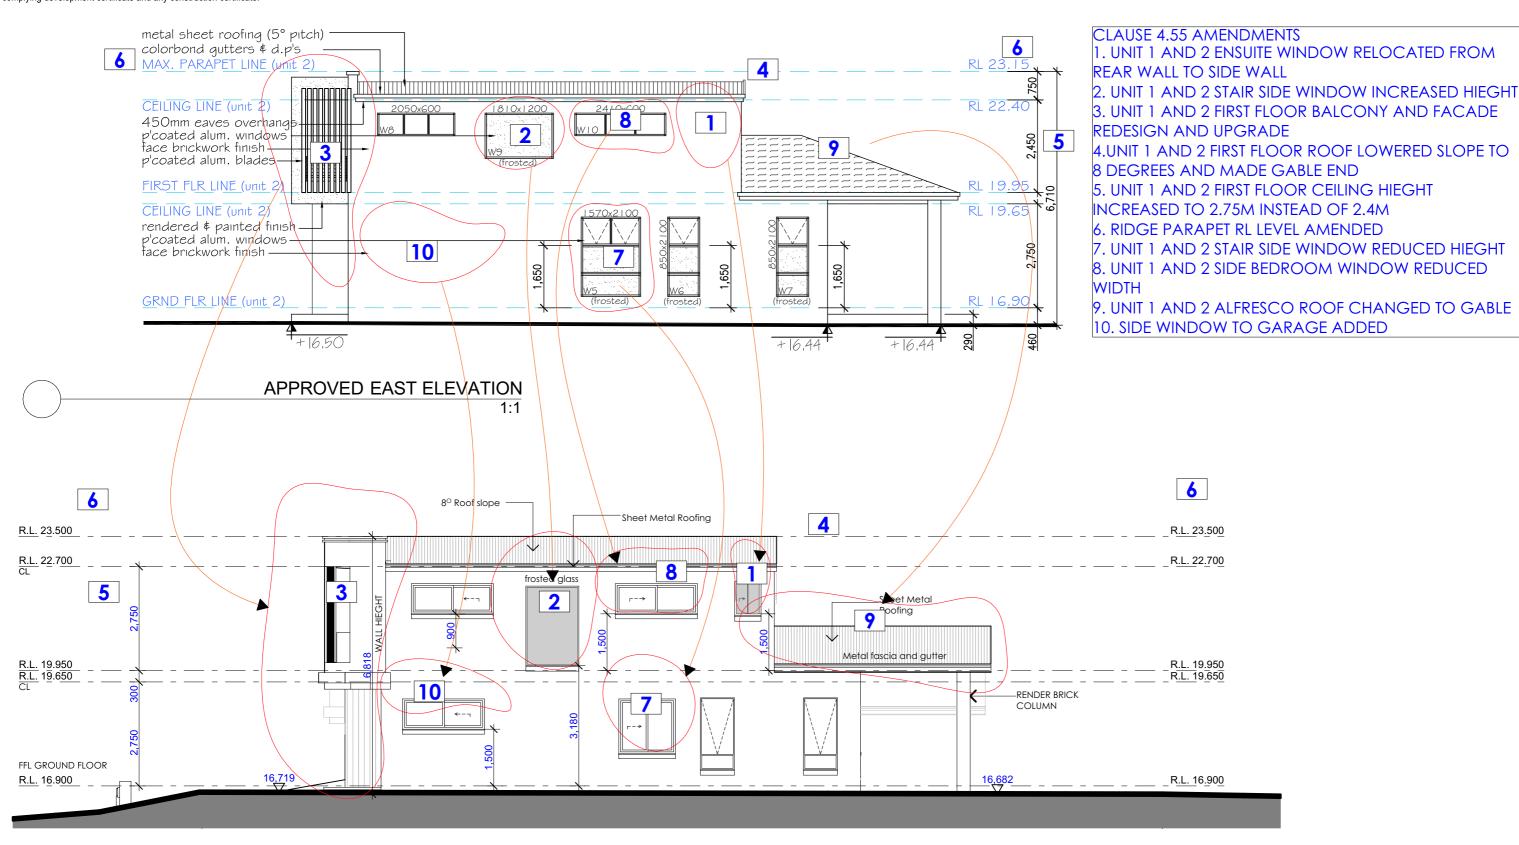


PROPOSED ATTACHED DUAL
OCCUPANCY AMENDED DA CLAUSE 4.55 Sheet Title: APPROVED AND REVISED ELEVATIONS

Client Address

Mr HAYDAR ALI 11 HARDEN CRES GEORGES HALL LOT 22 DP236764

SES | Scale | 1:1, 1:100 | Drawing No.: | Sheet Number: 5 | |



PROPOSED CLAUSE 4.55 EAST ELEVATION
1:100

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PROPOSED ATTACHED DUAL
OCCUPANCY AMENDED DA CLAUSE 4.55 Sheet Title: APPROVED AND REVISED ELEVATIONS


Mr HAYDAR ALI

11 HARDEN CRES GEORGES
HALL LOT 22 DP236764

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Drawing No.:

The Number: 6

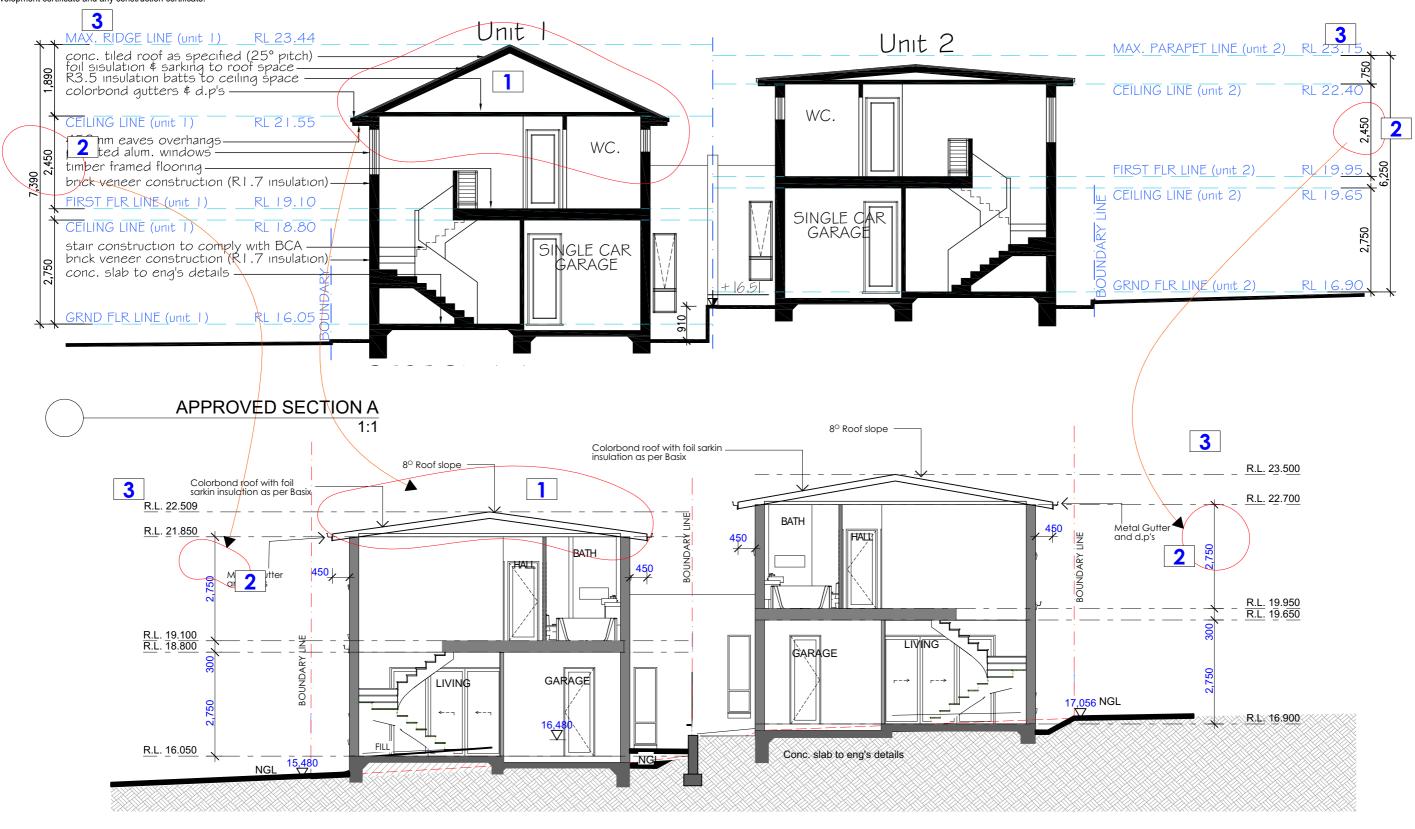

PROPOSED CLAUSE 4.55 SECTION A

CLAUSE 4.55 AMENDMENTS

1.UNIT 1 AND 2 FIRST FLOOR ROOF LOWERED SLOPE TO 8 DEGREES AND MADE GABLE END

2. UNIT 1 AND 2 FIRST FLOOR CEILING HIEGHT INCREASED TO 2.75M INSTEAD OF 2.4M

3. RIDGE PARAPET RL LEVEL AMENDED

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OCCUPANCY AMENDED DA CLAUSE 4.55 Sheet Title:	APPROVED AND REVISED SECTION
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project	

Mr HAYDAR ALI


Mr HAYDAR ALI

Address

11 HARDEN CRES GEORGES
HALL LOT 22 DP236764

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 Date/Revision
 05/01/25


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 Drawing No.: 11 hardencres
 Sheet Number: 7

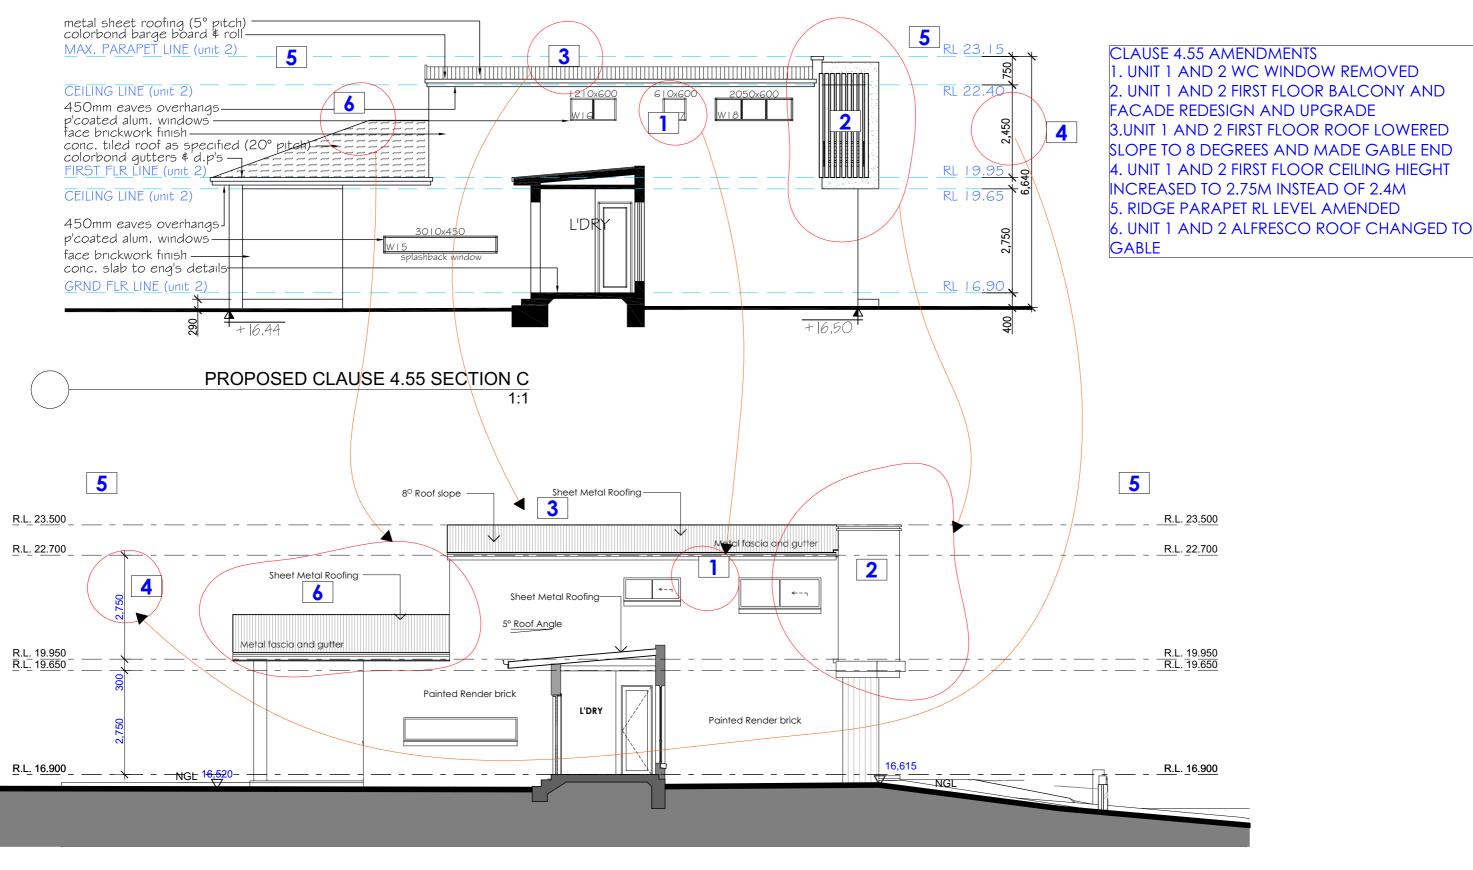

PROPOSED CLAUSE 4.55 SECTION C

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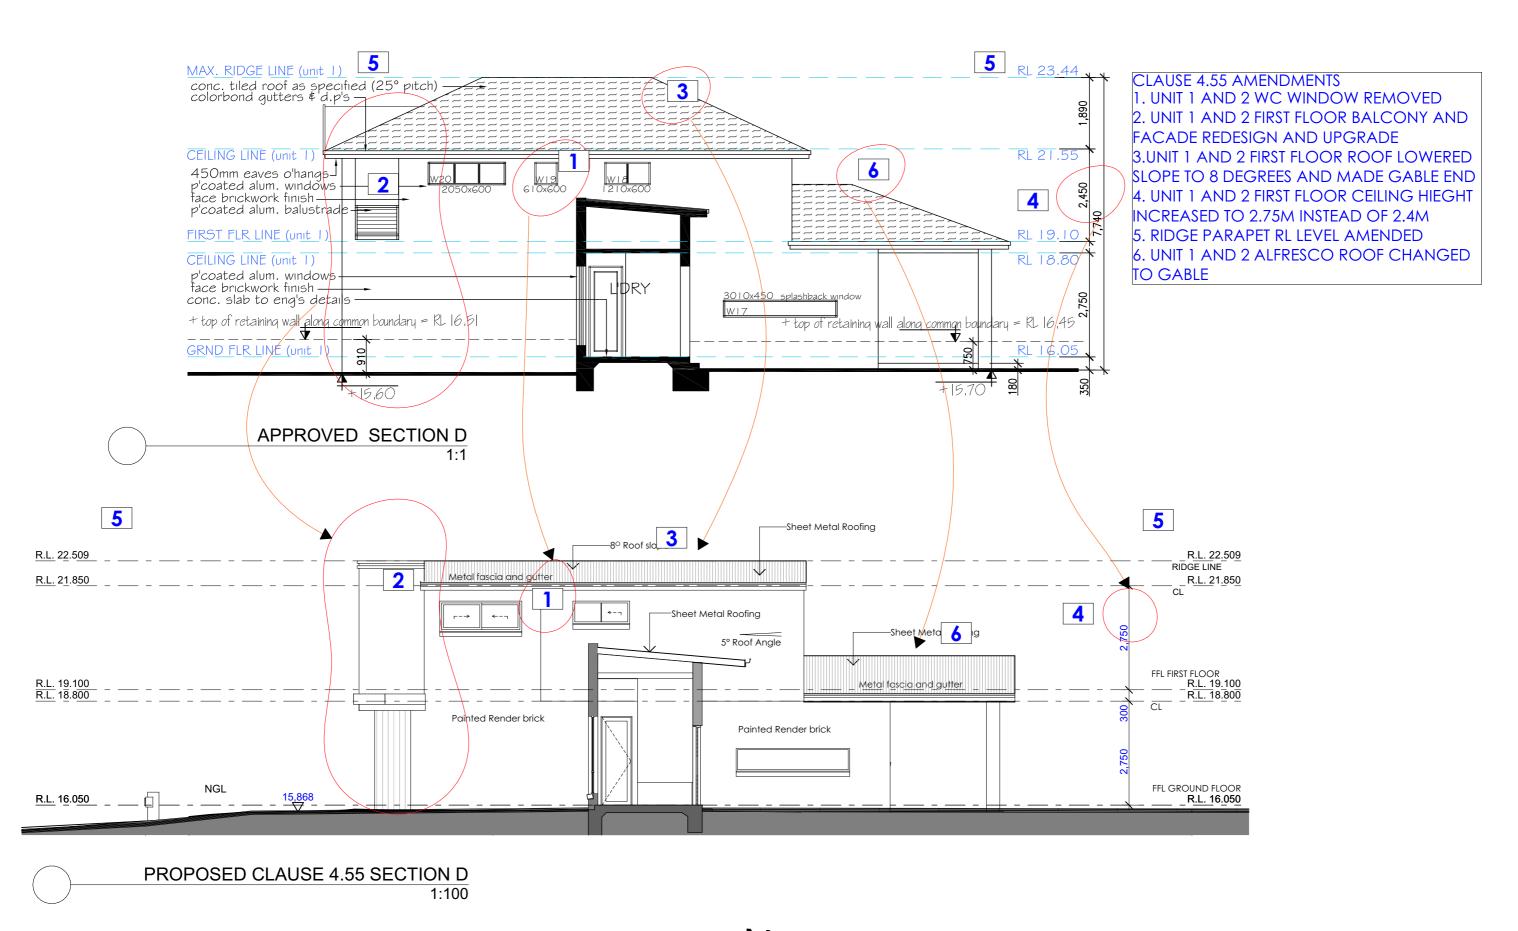


PROPOSED ATTACHED DUAL OCCUPANCY AMENDED DA CLAUSE 4.55 Sheet Title: APPROVED AND REVISED SECTIONS

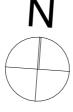 Client
 Address
 S

 Mr HAYDAR ALI
 11 HARDEN CRES GEORGES
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 HALL LOT 22 DP236764
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PROPOSED ATTACHED DUAL
OCCUPANCY AMENDED DA CLAUSE 4.55 Sheet Title: APPROVED AND REVISED SECTIONS

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 Address
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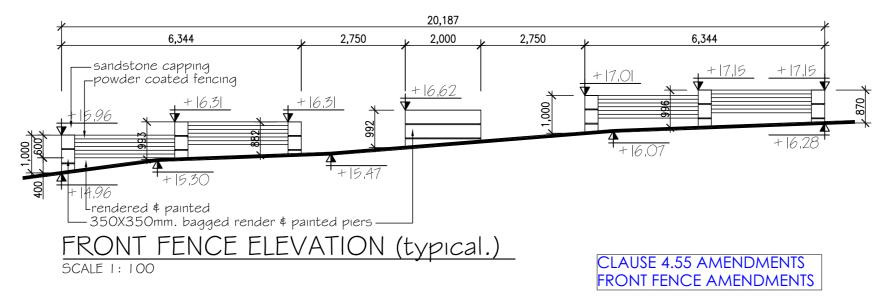
 Mr HAYDAR ALI
 11 HARDEN CRES GEORGES
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 HALL LOT 22 DP236764
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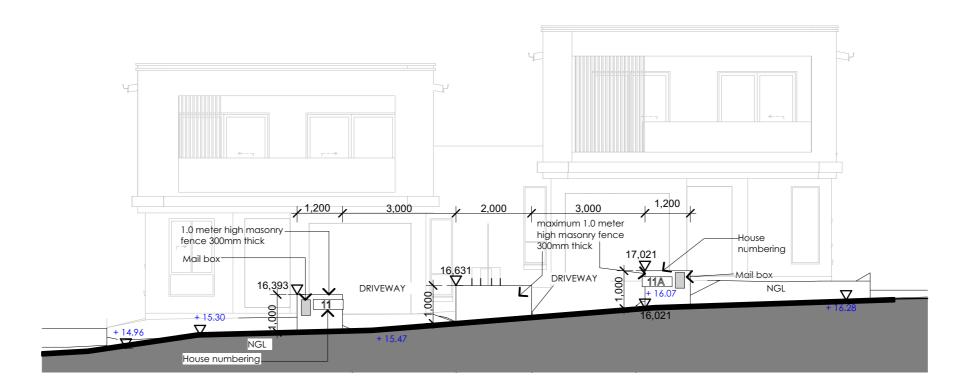
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| Prawing No.: | Sheet Number: 9

Date/Revision




APPROVED FRONT FENCE



PROPOSED CLAUSE 4.55 FRONT FENCE ELEVATION
1:100

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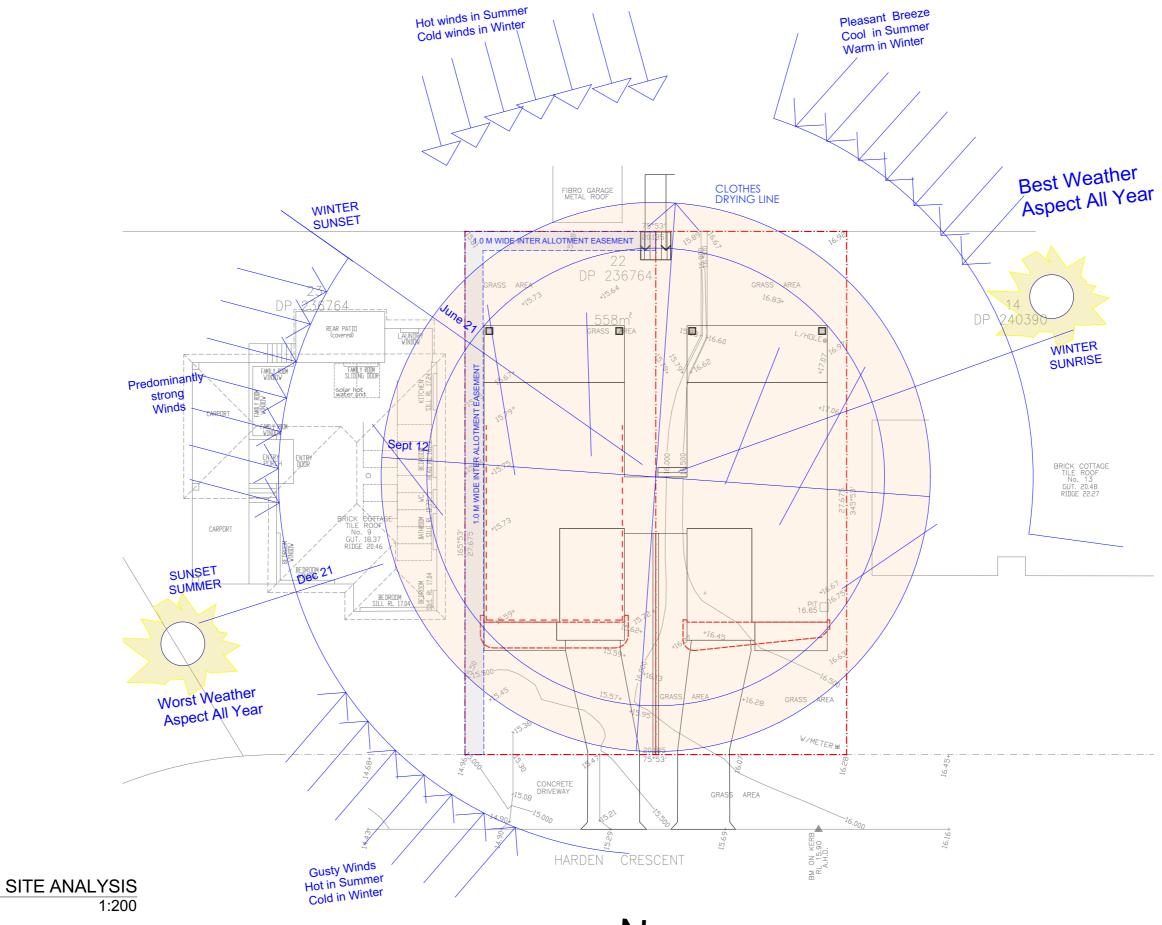
PROPOSED ATTACHED DUAL OCCUPANCY AMENDED DA CLAUSE 4.55 Sheet Title: APPROVED AND REVISED FRONT FENCE

Mr HAYDAR ALI

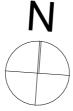Mr HAYDAR ALI

Address

11 HARDEN CRES GEORGES
HALL LOT 22 DP236764



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PROPOSED ATTACHED DUAL
OCCUPANCY AMENDED DA CLAUSE 4.55 Sheet Title: SITE ANALYSIS

 Date/Revision
 Date/Revision

 05/01/25

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 Sheet Number:


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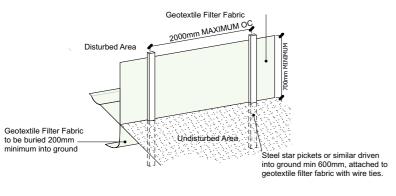
Quality of Work: All work carried out must comply with: Building Code of Australia to the extent required under Environmental Planning Assessment Act 1979, all other relevant codes, standards and specifications that the work is required to comply with under any law and the conditions of any relevant development consent or complying development certificate and any construction certificate.


SEDIMENTATION CONTROL NOTES

ALL EROSION AND SEDIMENTATION CONTROL MEASURE, INCLUDING REVEGETATION AND STORAGE OF SOIL AND TOPSOIL, SHALL BE IMPLEMENTED TO THE STANDARDS OF THE SOIL CONSERVATION OF NSW.

- 2. DRAINAGE WORKS SHALL BE CONSTRUCTED AROUND ALL INLET PITS, CONSISTING OF 300MM W X 300MM D TRENCH.
- 3. ALL SEDIMENT BASINS AND TRAPS SHALL BE CLEANED WHEN AT A MAXIMUM OF 60% FULL OF SOIL MATERIALS.
- 4. ALL DISTURBED AREAS SHALL BE REVEGETATED AS SOON AS THE RELEVANT WORKS ARE COMPLETED.
- 5. SOIL AND TOPSOIL STOCKPILES SHALL BE LOCATED AWAY FROM DRAINAGE LINES AND AREAS WHERE WATER MAY CONCENTRATE.
- 6. FILTER SHALL BE CONSTRUCTED BY STRETCHING A FILTER FABRIC (PROPEX OR EQUIVALENT) BETWEEN POSTS AT 2M CENTRES. FABRIC SHALL BE BURIED 200MM ALONG THE BOTTOM EDGE.



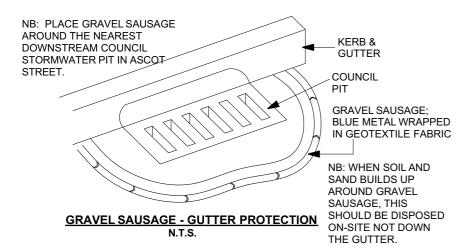

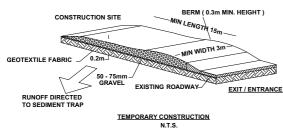


NOTE:

IN ACCORDANCE WITH SECTION 80 A (11) OF THE ENVIRONMENTAL PLANNING & ASSESSMENT ACT 1979 AND CLAUSE 98 OF THE ENVIRONMENTAL PLANNING & ASSESSMENT REGULATION 2000, IT IS A PRESCRIBED CONDITION THAT ALL BUILDING WORK MUST BE CARRIED OUT IN ACCORDANCE WITH THE PROVISIONS OF THE BUILDING CODE OF AUSTRALIA (BCA).

DEMOLITION WORK NOTE:

A DEMOLITION WORK MUST BE IN ACCORDANCE WITH AUSTRALIAN STANDARD AS2601-2001, DEMOLITION OF STRUCTURES AND RELEVANT ENVIRONMENTAL / OCCUPATIONAL HEALTH AND SAFETY REQUIREMENTS.

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DEMOLITION PLAN

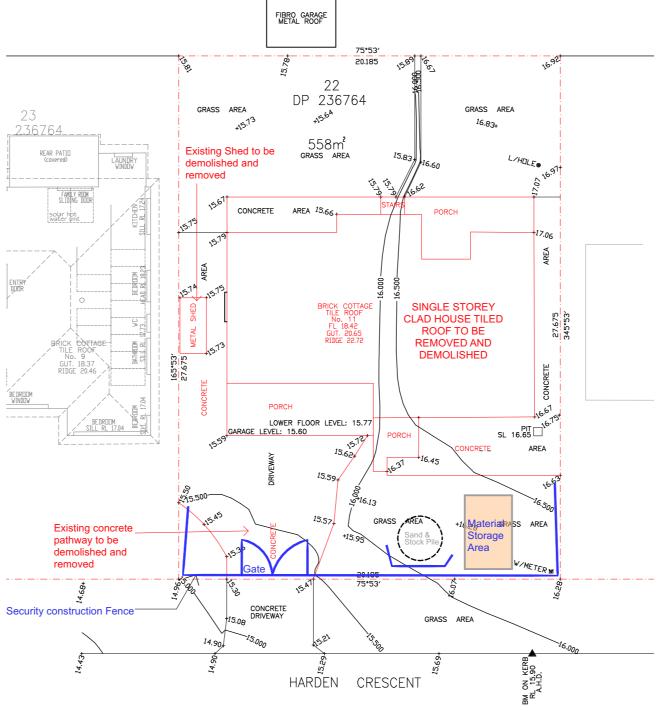

PROPOSED ATTACHED DUAL OCCUPANCY AMENDED DA CLAUSE 4.55 Sheet Title: DEMOLITION PLAN

Client Mr HAYDAR ALI

1:200

Construction Management Plan

-Details of any signage to be erected on the site

Location of any plant or equipment

Construction and delivery vehicles

interfere with locating plant or equipment in the required area.

-Location of any plant & equipment (cranes, hoists.etc)

-Location of material storage.

-Intended timing of deliveries to site

general site cleaning as necessary.

immediately

or adjoining properties.

Timing of deliveries

48 hours prior to commencement.

Location of Material Storage

handling from delivery truck to storage area.

and to provide security against theft.

Signage

Hours of Work

Vehicle access and egress

Material delivery and handling

Holidays, Refer Council's DA Determination Notes.

Communication with adjoining residents

Materials will be stored on site in locations marked or shown Below:

Location "C" - New floor platform- internal finishing materials

NOTE - Material deliveries are to be timed so that only materials required for the scope of works to be carried out at

location of this signage is shown on the associated plans

Clean run off is to be diverted around disturbed areas

Slope gradient & flow distance are to be minimised

Disturbed areas are to be promptly rehabilitated

access for trades/residents to and from the site.

Soil & Water Management Plans

before the materials will be required on site.

The following Construction Management Plan will highlight the following:

-Maximum intended weight and size of construction and delivery vehicles

-Intended communication of construction details to adjoining residents

-Contact details for of person with authority to respond to any construction related

Plant and equipment (cranes, hoists, rubbish bins etc.) will be located in Location "B"

(front yard) to avoid damage to existing established landscape to the rear of the

NOTE - Use of plant & equipment is to be timed so that material storage does not

Construction vehicles will generally take the shape of trade utes/vans. Delivery

vehicles are to be of fixed tray type with maximum weight of 3 tonnes. Concrete delivery is to be in the more of mini-mix vehicle. Rubbish bins are to be limited to 4

Construction vehicles (utes/vans) can access and egress the site without any

special requirements. Delivery trucks are not to enter the site and must stay on the public, road to avoid damage to road crossing, footpath and or driveway.

Materials delivered to site are to be unloaded from delivery truck on site wherever

unloading is not possible on site materials are to be unloaded at street level and manually carried onto site and stored in appropriate locations as specified

NOTE- At no time are materials to be stored on the road, access handle, nature strip

All Construction / Demolition work relating to the Development Consent within the

city must be carried out between the hours of 7:00am to 5:00pm Mondays to Fridays

and 7:00am to 12:00 noon on Saturday. No work is to be done on Sunday and Public

Material deliveries will generally take place between 8:00am and 3:00pm the day

Upon receipt of the Construction Certificate the adjoining residents will be notified

that works are being arranged to begin. This will provide approximately 3 weeks'

notice in this regard. This notification will include all contact details per above. Further

Location marked = (side access for proposed driveway) heavy/bulky materials such

Timber/Pre-Fabricated frames and trusses etc will be stored on the front lawn. These

as bricks/steel/roof tiles etc will be stored in this area in order to allow lifting off

delivery truck and placement for storage without "double handling" of materials.

materials are generally of longer lengths and light enough to allow manual

(Skirting/architraves/doors etc_ will be stored internally within the new area as

directed by the builder for protection from weather. Fragile materials such as tiles, plumbing fittings and fixtures etc will be stored in the old study/bedroom area o

r rooms not generally used by the proprietors so as to minimize possibility of damage

that stage are on site in order to ensure the site is not cluttered and to allow easy

Signage in the form of a site sign to identify the Builder's and Architects names and contact details and the Principal certifying Authority will be required on site. The

All sediment controls are to be installed before work commence. Any areas

of exposed soil are to be minimised. All top-soil is to be retained on site for re-use

areas are to be as indicated by the Construction Management Plan to preserve existing vegetation. Surface water flows during construction are to be controlled as

Material & soil stockpiles are to be protected sediment fencing. Stockpiles and work

Sediment fence are to be regularly monitored and manufactured during construction.

to this the Construction Supervisor will introduce himself to these residents a minimum of

possible and stored in appropriate location as specified immediately. Where

cubic metre bins during demolition stage and reduced to 3 cubic metre bins for


Sheet Number: 12


Date/Revision

05/01/25

11 HARDEN CRES GEORGES HALL LOT 22 DP236764


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	PROPOSED ATTACHED DUAL	
	OCCUPANCY AMENDED DA CLAUSE 4.55 Sheet Title:	SUBDIVISION PLAN

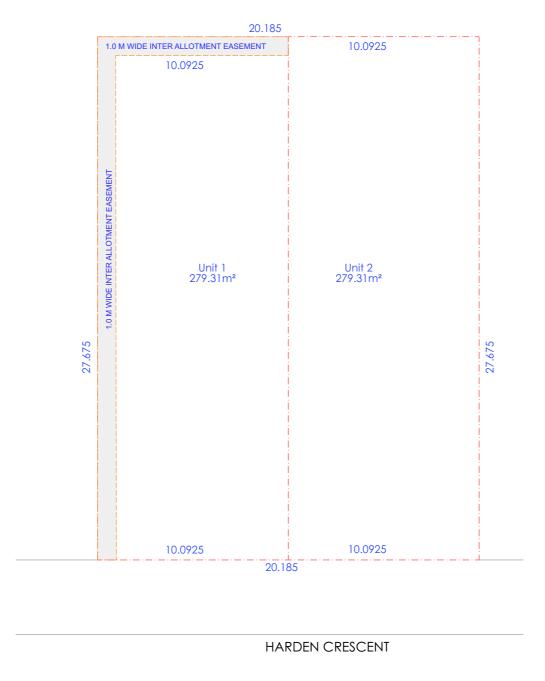Client Address

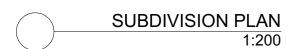Mr HAYDAR ALI 11 HARDEN CRES GEORGES HALL LOT 22 DP236764

 Scale
 1:200
 Date/Revision
 05/01/25

 Issue
 F
 Drawing No.: 11 hardencres
 Sheet Number: 13
 Quality of Work: All work carried out must comply with: Building Code of Australia to the extent required under Environmental Planning Assessment Act 1979, all other relevant codes, standards and specifications that the work is required to comply with under any law and the conditions of any relevant development consent or complying development certificate and any construction certificate.

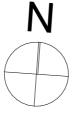Construction Management Plan

The following Construction Management Plan will highlight the following: -Location of material storage.

-Location of any plant & equipment (cranes, hoists.etc)

-Maximum intended weight and size of construction and delivery vehicles

-Contact details for of person with authority to respond to any construction related

-Intended communication of construction details to adjoining residents

-Details of any signage to be erected on the site

Location of any plant or equipment

Plant and equipment (cranes, hoists, rubbish bins etc.) will be located in Location "B" (front yard) to avoid damage to existing established landscape to the rear of the

NOTE - Use of plant & equipment is to be timed so that material storage does not interfere with locating plant or equipment in the required area.

Construction and delivery vehicles

Construction vehicles will generally take the shape of trade utes/vans. Delivery vehicles are to be of fixed tray type with maximum weight of 3 tonnes. Concrete delivery is to be in the more of mini-mix vehicle. Rubbish bins are to be limited to 4 cubic metre bins during demolition stage and reduced to 3 cubic metre bins for general site cleaning as necessary.

Vehicle access and egress

Construction vehicles (utes/vans) can access and egress the site without any special requirements. Delivery trucks are not to enter the site and must stay on the public, road to avoid damage to road crossing, footpath and or driveway.

Material delivery and handling

Materials delivered to site are to be unloaded from delivery truck on site wherever possible and stored in appropriate location as specified immediately. Where unloading is not possible on site materials are to be unloaded at street level and manually carried onto site and stored in appropriate locations as specified immediately.

NOTE- At no time are materials to be stored on the road, access handle, nature strip or adjoining properties.

Hours of Work

All Construction /Demolition work relating to the Development Consent within the city must be carried out between the hours of 7:00am to 5:00pm Mondays to Fridays and 7:00am to 12:00 noon on Saturday. No work is to be done on Sunday and Public Holidays. Refer Council's DA Determination Notes.

Timing of deliveries

Material deliveries will generally take place between 8:00am and 3:00pm the day before the materials will be required on site.

Communication with adjoining residents

Upon receipt of the Construction Certificate the adjoining residents will be notified that works are being arranged to begin. This will provide approximately 3 weeks' notice in this regard. This notification will include all contact details per above. Further to this the Construction Supervisor will introduce himself to these residents a minimum of 48 hours prior to commencement.

Location of Material Storage

Materials will be stored on site in locations marked or shown Below:
Location marked = (side access for proposed driveway) heavy/bulky materials such as bricks/steel/roof tiles etc will be stored in this area in order to allow lifting off delivery truck and placement for storage without "double handling" of materials. Timber/Pre-Fabricated frames and trusses etc will be stored on the front lawn. These materials are generally of longer lengths and light enough to allow manual handling from delivery truck to storage area.

Location "C" - New floor platform- internal finishing materials

(Skirting/architraves/doors etc_ will be stored internally within the new area as directed by the builder for protection from weather. Fragile materials such as tiles, plumbing fittings and fixtures etc will be stored in the old study/bedroom area o rooms not generally used by the proprietors so as to minimize possibility of damage and to provide security against theft.

NOTE - Material deliveries are to be timed so that only

materials required for the scope of works to be carried out at that stage are on site in order to ensure the site is not cluttered and to allow easy

access for trades/residents to and from the site.

Signage

Signage in the form of a site sign to identify the Builder's and Architects names and contact details and the Principal certifying Authority will be required on site. The location of this signage is shown on the associated plans

Soil & Water Management Plans

All sediment controls are to be installed before work commence. Any areas of exposed soil are to be minimised. All top-soil is to be retained on site for re-use. Material & soil stockpiles are to be protected sediment fencing. Stockpiles and work areas are to be as indicated by the Construction Management Plan to preserve existing vegetation. Surface water flows during construction are to be controlled as

Clean run off is to be diverted around disturbed areas

Disturbed areas are to be promptly rehabilitated


Sediment fence are to be regularly monitored and manufactured during construction. Slope gradient & flow distance are to be minimised


SEDIMENTATION CONTROL NOTES


ALL EROSION AND SEDIMENTATION CONTROL MEASURE, INCLUDING REVEGETATION AND STORAGE OF SOIL AND TOPSOIL, SHALL BE IMPLEMENTED TO THE STANDARDS OF THE SOIL CONSERVATION OF NSW.

- 2. DRAINAGE WORKS SHALL BE CONSTRUCTED AROUND ALL INLET PITS, CONSISTING OF 300MM W X 300MM D TRENCH.
- 3. ALL SEDIMENT BASINS AND TRAPS SHALL BE CLEANED WHEN AT A MAXIMUM OF 60% FULL OF SOIL MATERIALS.
 4. ALL DISTURBED AREAS SHALL BE REVEGETATED AS SOON AS THE
- RELEVANT WORKS ARE COMPLETED.

 5. SOIL AND TOPSOIL STOCKPILES SHALL BE LOCATED AWAY FROM DRAINAGE
- SOIL AND TOPSOIL STOCKPILES SHALL BE LOCATED AWAY FROM DRAINAGE LINES AND AREAS WHERE WATER MAY CONCENTRATE.
- 6. FILTER SHALL BE CONSTRUCTED BY STRETCHING A FILTER FABRIC (PROPEX OR EQUIVALENT) BETWEEN POSTS AT 2M CENTRES. FABRIC SHALL BE BURIED 200MM ALONG THE BOTTOM EDGE.

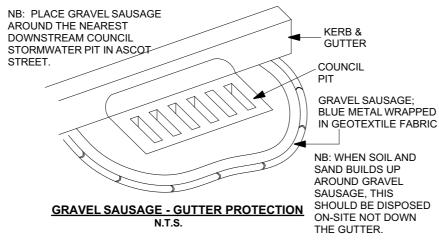

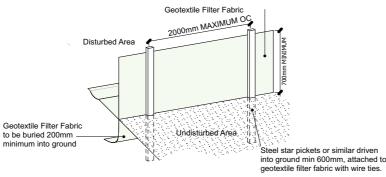

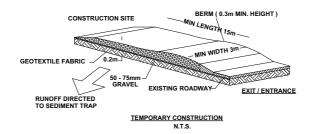

NOTE:

IN ACCORDANCE WITH SECTION 80 A (11) OF THE ENVIRONMENTAL PLANNING & ASSESSMENT ACT 1979 AND CLAUSE 98 OF THE ENVIRONMENTAL PLANNING & ASSESSMENT REGULATION 2000, IT IS A PRESCRIBED CONDITION THAT ALL BUILDING WORK MUST BE CARRIED OUT IN ACCORDANCE WITH THE PROVISIONS OF THE BUILDING CODE OF AUSTRALIA (BCA).


DEMOLITION WORK NOTE:

A DEMOLITION WORK MUST BE IN ACCORDANCE WITH AUSTRALIAN STANDARD AS2601-2001, DEMOLITION OF STRUCTURES AND RELEVANT ENVIRONMENTAL / OCCUPATIONAL HEALTH AND SAFETY REQUIREMENTS.

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SEDIMENT CONTROL PLAN 1:200

PROPOSED ATTACHED DUAL OCCUPANCY AMENDED DA CLAUSE 4.55 Sheet Title: SEDIMENT CONTROL PLAN

Client Address Scale 1:200

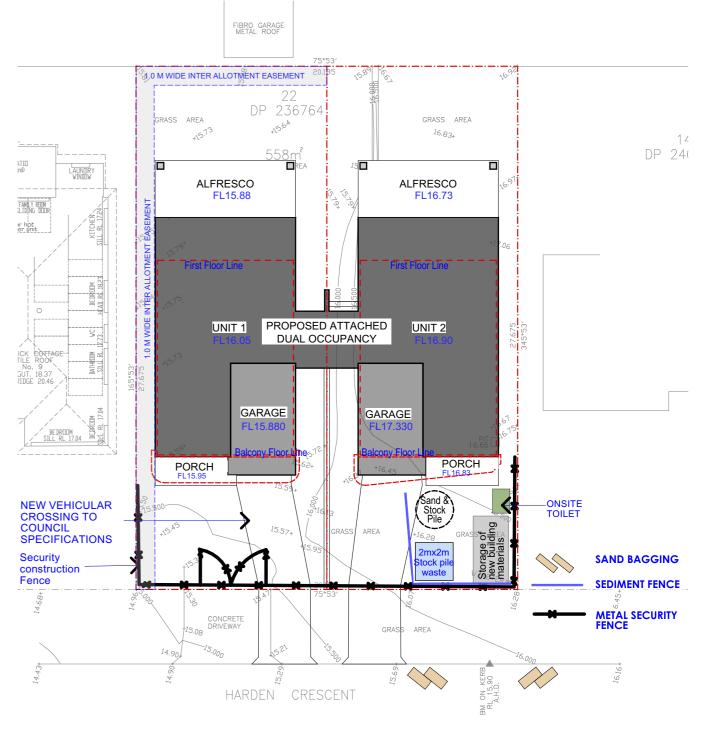Mr HAYDAR ALI 11 HARDEN CRES GEORGES

HALL LOT 22 DP236764

Date/Revision

Quality of Work: All work carried out must comply with: Building Code of Australia to the extent required under Environmental Planning Assessment Act 1979, all other relevant codes, standards and specifications that the work is required to comply with under any law and the conditions of any relevant development consent or complying development certificate and any construction certificate.

ENVIRONMENTAL SITE MANAGEMENT NOTES

- · All existing trees to be retained unless shown otherwise on approved Architect's or Landscape drawings. Trees retained are to be protected with a high visibility fence, plus flagging to individual trees as necessary.
- Retain all existing grass cover wherever possible.
- Sediment and erosion controls must be in place prior to the commencement of any earthworks of demolition activity.
- Install temporary sediment barriers to all inlet pits likely to collect silt laden water, until surrounding areas are paved or regrassed.
- All silt fences and barriers are to be maintained in good order and regularly desilted during the construction period.
- It is the responsibility of the contractor to ensure that all measures are taken during the course of construction to prevent sediment erosion and pollution of the downstream system. Supervising engineer should be contacted if in doubt.
- · It is the responsibility of the contractor to ensure that all measures are taken during the course of construction to prevent sediment erosion and pollution of the downstream system. Supervising engineer should be contacted if in doubt.
- Waste materials are to be stockpiled or loaded into Utility vehicles located as
- stockpiles of loose material such as sand, soil, gravel must be covered with geotextile silt fence material. Plastic sheeting or membrane must not be used. Safety barricading should be used to isolate stockpiles of solid materials such as steel reinforcing, formwork, scaffolding.
- · All vehicles leaving the site must pass over the 'ballast' area to shake off site clay and soil. If necessary wheels and axles are to be hose down. Ballast is to be maintained and replaced as necessary during the construction period.
- Delivery and other motor vehicles removing excavated material should travel on stabilised construction paths and material should be taken to the truck to reduce truck movement on the site.
- Any sediment deposit on the public way, including footpath reserve and road surface, is to be removed immediately.
- Provide barriers round all construction works within the footpath area to provide safe access for pedestrians.
- Concrete pumps and cranes are to operate from within the ballast entry driveway area and are not to operate from the public roadway unless specific council permission is obtained
- delivery vehicles must not stand within the public roadway for more than 20 minutes at a time.
- Any excavation work adjacent to adjoining properties or the public roadway is not to be commenced until the structural engineer is consulted and specific instructions received from the engineer.
- · Toilet facilities must be either a flushing type or approved portable chemical closet. Chemical closets are to be maintained and serviced on a regular basis so that offensive odour is not emitted.

SEDIMENTATION CONTROL NOTES

- ALL EROSION AND SEDIMENTATION CONTROL MEASURE, INCLUDING REVEGETATION AND STORAGE OF SOIL AND TOPSOIL, SHALL BE IMPLEMENTED TO THE STANDARDS OF THE SOIL CONSERVATION OF NSW.
- 2. DRAINAGE WORKS SHALL BE CONSTRUCTED AROUND ALL INLET PITS, CONSISTING OF 300MM W X 300MM D TRENCH.
- 3. ALL SEDIMENT BASINS AND TRAPS SHALL BE CLEANED WHEN AT A MAXIMUM OF 60% FULL OF SOIL MATERIALS. 4. ALL DISTURBED AREAS SHALL BE REVEGETATED AS SOON AS THE RELEVANT
- WORKS ARE COMPLETED 5. SOIL AND TOPSOIL STOCKPILES SHALL BE LOCATED AWAY FROM DRAINAGE
- LINES AND AREAS WHERE WATER MAY CONCENTRATE. 6. FILTER SHALL BE CONSTRUCTED BY STRETCHING A FILTER FABRIC (PROPEX

OR EQUIVALENT) BETWEEN POSTS AT 2M CENTRES. FABRIC SHALL BE BURIED 200MM ALONG THE BOTTOM EDGE.

Soil Management

All excess soil on site generated as a result of necessary excavations to be re-used as fill to sub base of raft slab and to achieve a levelled building platform.

Termite Protection Note

LISED ABOVE CONTACT ADAM NASSER 0435237853

Kordon Termite Barrier to be installed to perrimeter of building and to all drainage pipe penetrations

Soil Note

Slab Level to form Datum to be Determined on Site & to Existing FFL Retaining walls to be completed to engineers details (if required) Sewer connection to Existing Connection Dish drains (if Needed) to Authorities Details Smoke Alarms to be Mains Connected There are no existing trees to be removed.

KEEP FOOT PATH AND PUBLIC PEDESTRIAN AREA CLEAN AND CLEAR AT ALL TIMES

IMPORTANT NOTES

CONDENSATION MANAGEMENT SHALL BE IN ACCORDANCE WITH NCC 2019 PART3.8.7 APPLY AN APPROPRIATE TERMITE MANAGEMENT SYSTEM IN ACCORDANCE WITH PART 3.1.3 OF THE NCC


NOTE: COUNCIL ISSUED FOOTWAY DESIGN LEVELS


COUNCIL'S ISSUED FOOTWAY DESIGN LEVELS TO BE INCORPORATED INTO THE FINISHED LEVELS ONCE ISSUED BY COUNCIL


NO EXCAVATIONS TO BE CARRIED OUT WITHIN FOOTPATH AND PUBLIC PEDESTRIAN AREA WITHOUT CHECKING FOR DEPTH AND LOCATION OF

- 1. ALL EROSION AND SEDIMENTATION CONTROL MEASURES, INCLUDING REVEGETATION AND STORAGE OF SOIL AND TOPSOIL SHALL BE IMPLEMENTED TO THE STANDARDS OF THE SOIL CONSERVATION OF NSW.
- 2. ALL DRAINAGE WORKS SHALL BE CONSTRUCTED AND STABILIZED AS EARLY AS POSSIBLE DURING DEVELOPMENT.
- 3. SEDIMENT TRAPS SHALL BE CONSTRUCTED AROUND ALL INLET PITS, CONSISTING OF 300mm WIDE X 300mm DEEP TRENCH.
- 4. ALL SEDIMENT BASINS AND TRAPS SHALL BE CLEANED WHEN THE STRUCTURES ARE A MAXIMUM OF 60 % FULL OF SOIL MATERIALS, INCLUDING THE MAINTENANCE PERIOD.
- 5. ALL DISTURBED AREAS SHALL BE REVEGITATED AS SOON AS THE RELEVANT WORKS ARE COMPLETED.
- 6. SOIL AND TOPSOIL STOCKPILES SHALL BE LOCATED AWAY FROM DRAINAGE LINES AND AREA WHERE WATER MAY CONCENTRATE. 7. FILTER SHALL BE CONSTRUCTED BY STRETCHING A FILTER FABRIC (PROPEX OR APPROVED EQUIVALENT BETWEEN POST AT 3.0m

CENTRES. FABRIC SHALL BE BURIED 150mm ALONG ITS LOWER EDGE.

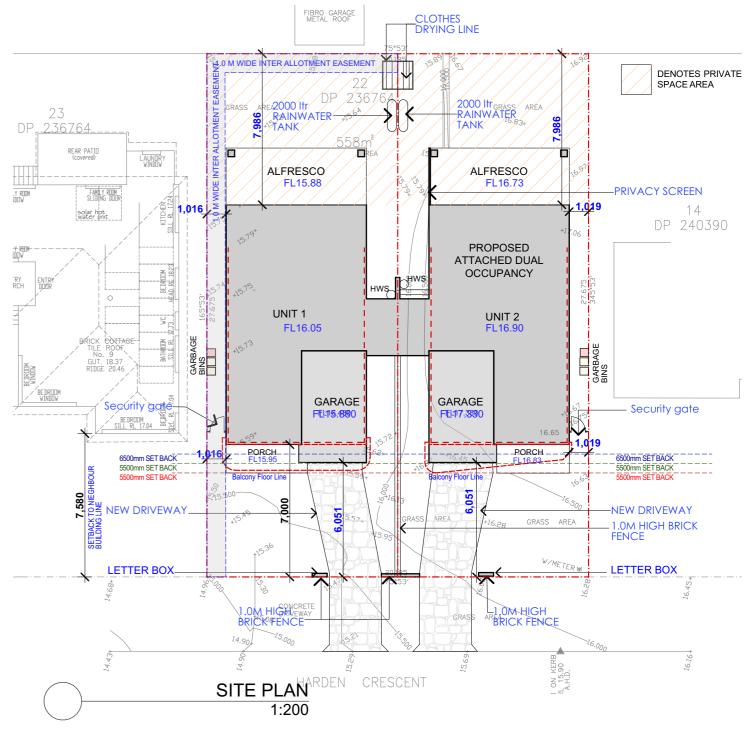

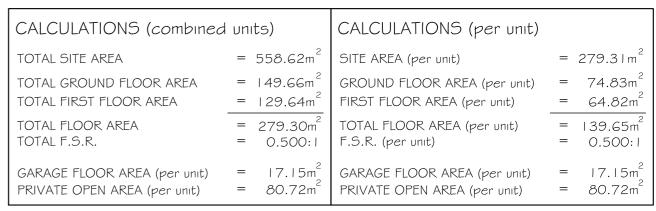

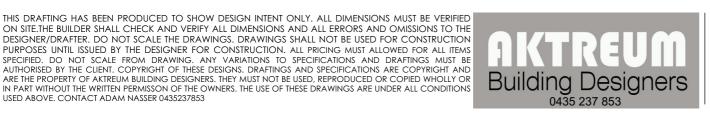




PROPOSED ATTACHED DUAL OCCUPANCY AMENDED DA CLAUSE 4.55 Sheet Title: SITE PLAN

Client 11 HARDEN CRES GEORGES Mr HAYDAR ALI HALL LOT 22 DP236764


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IMPORTANT NOTE:

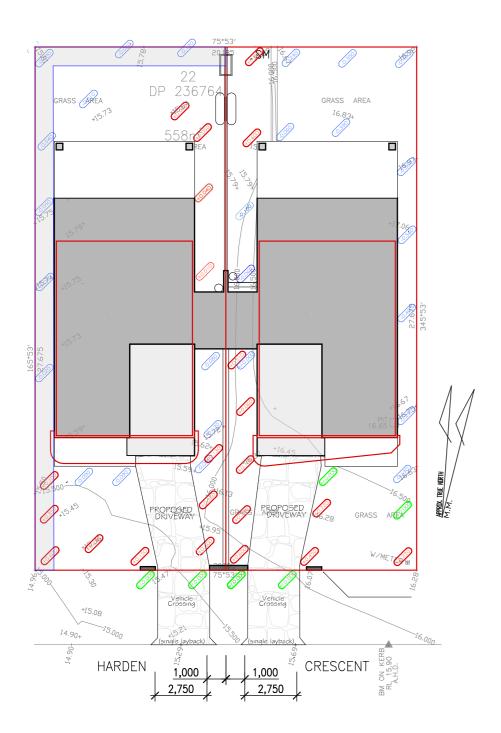BOUNDARY LINE LEVELS SHALL MATCH THE COUNCILS ISSUED BOUNDARY ALIGNMENT LEVELS NOTED WITHIN THE WORKS PERMIT





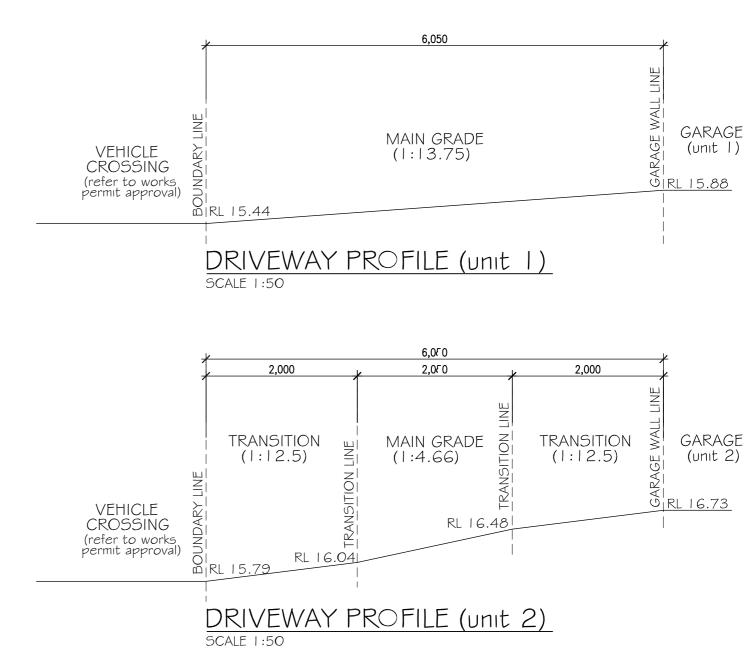

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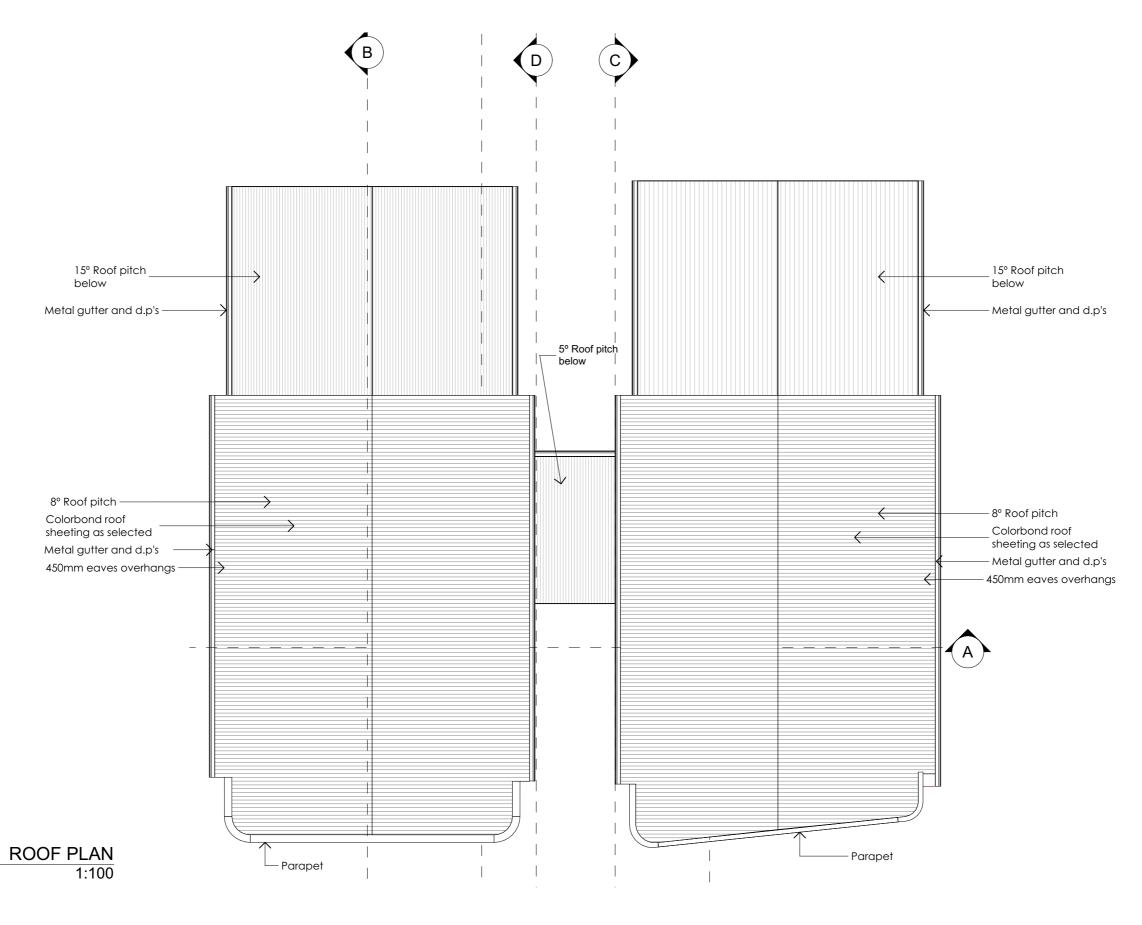
OCCUPANCY AMENDED DA CLAUSE 4.55 Sheet Title: DRIVEWAY PROFILES

Client 11 HARDEN CRES GEORGES Mr HAYDAR ALI HALL LOT 22 DP236764

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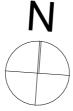
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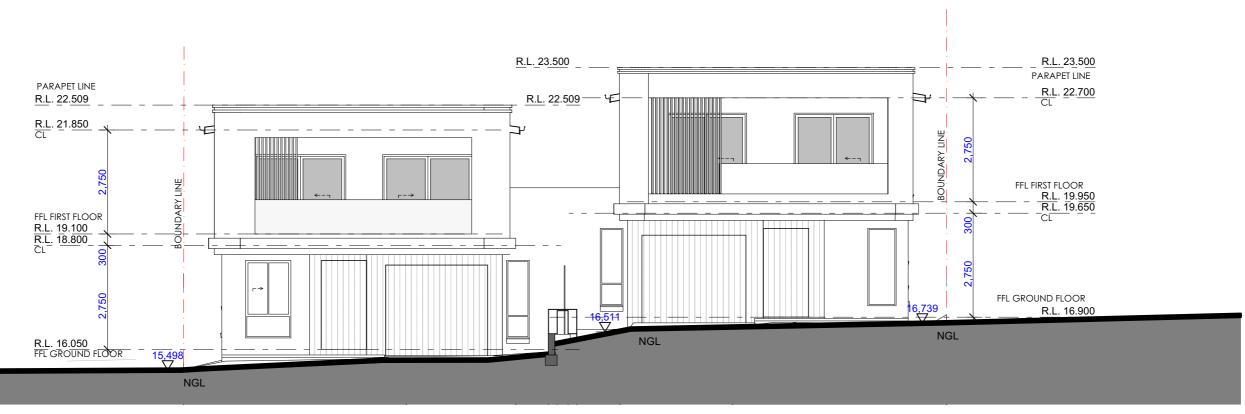
Mr HAYDAR ALI 11 HARDEN CRES GEORGES
HALL LOT 22 DP236764

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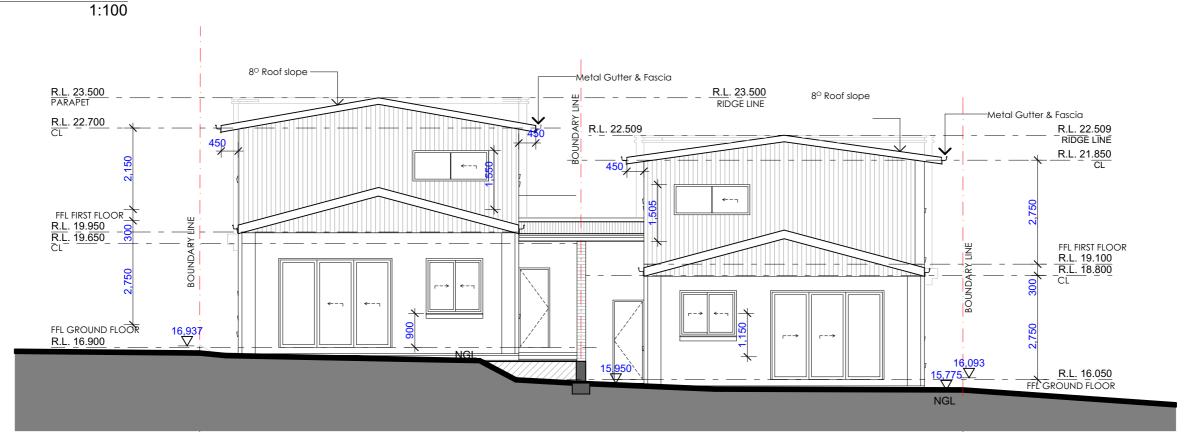
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SOUTH ELEVATION



NORTH ELEVATION

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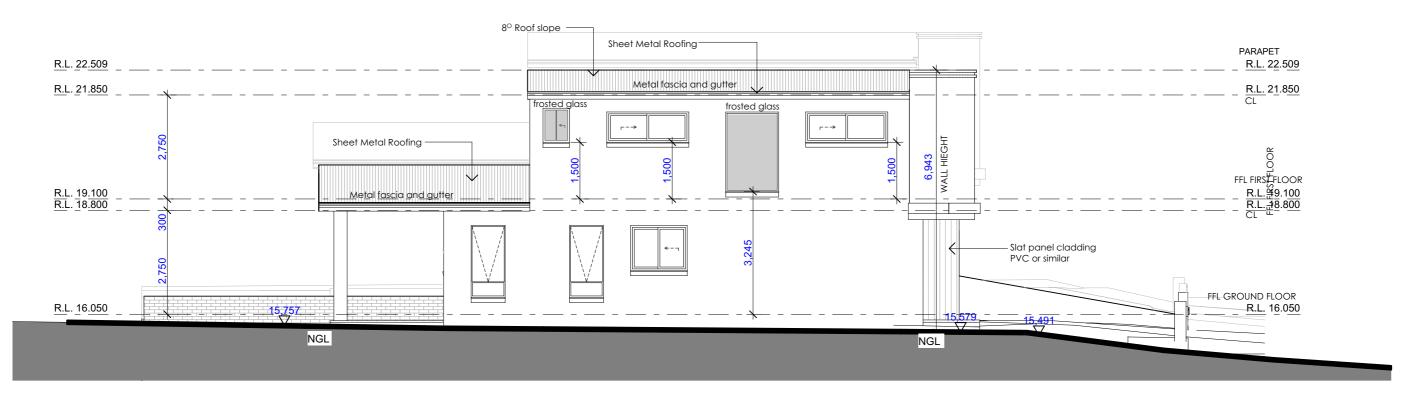
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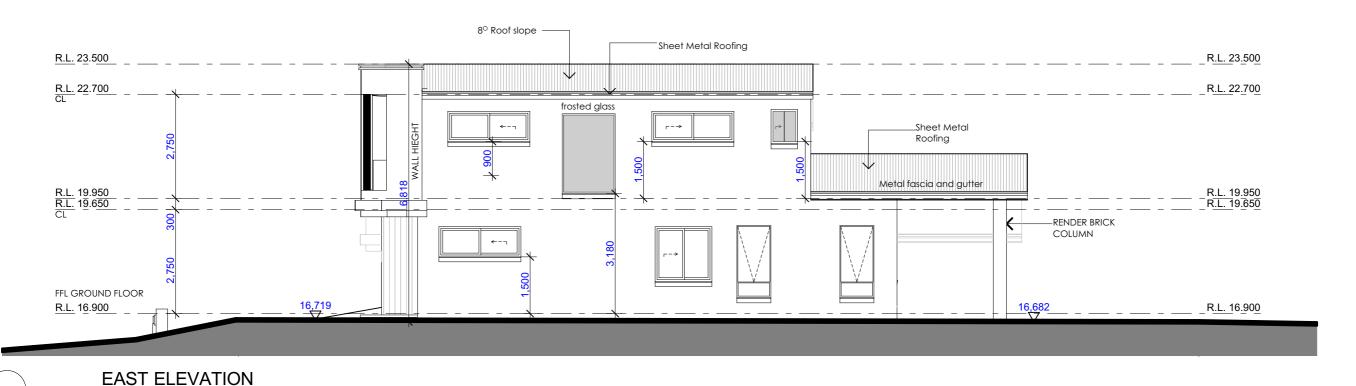
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WEST ELEVATION 1:100



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AKTREUM Building Designers ΝI


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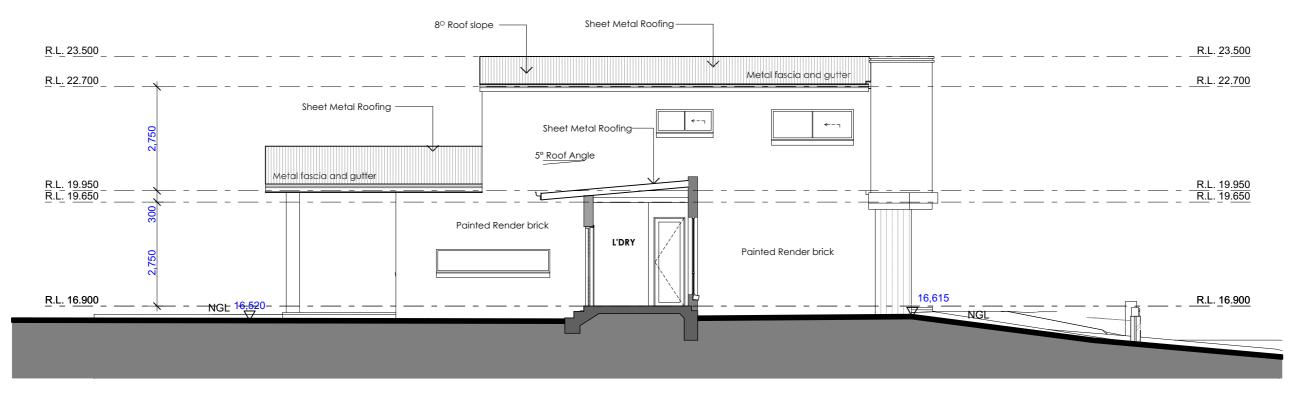
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SECTION B 1:100




SECTION WEST ELEVATION 1:100


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Client	Address	Scale	1:100		Date/Revision	05/01/25
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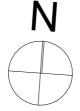
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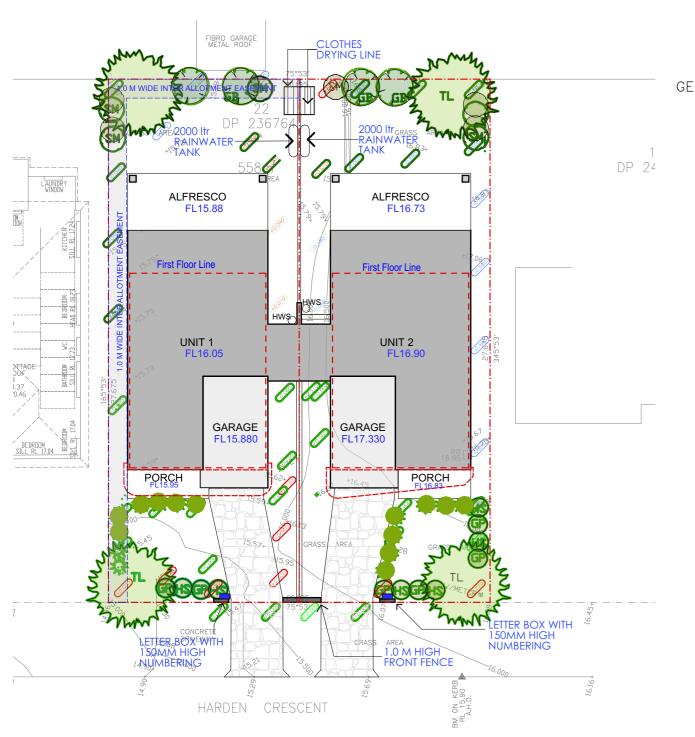



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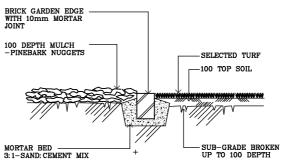
Client Address Sc Mr HAYDAR ALI 11 HARDEN CRES GEORGES — HALL LOT 22 DP236764 Iss
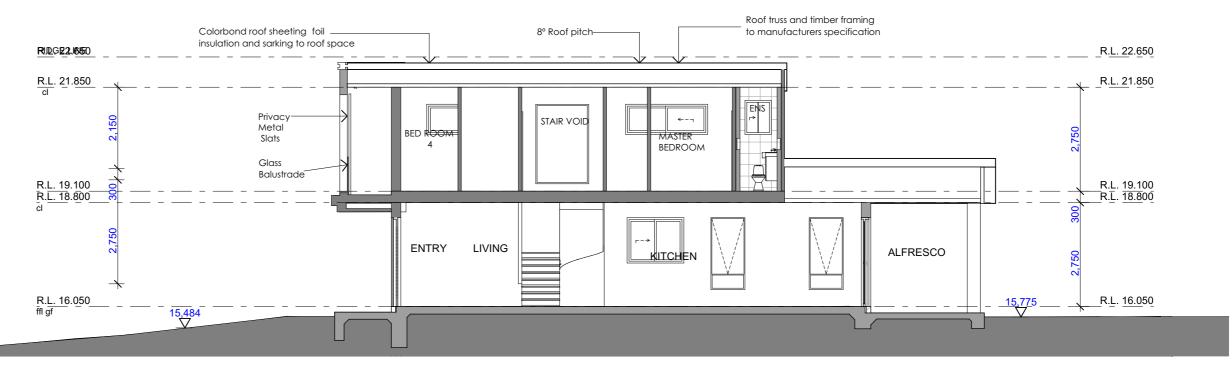
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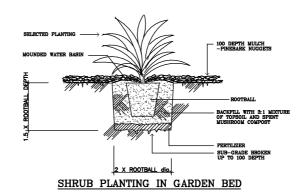
Parking No.: Sheet Number: 23

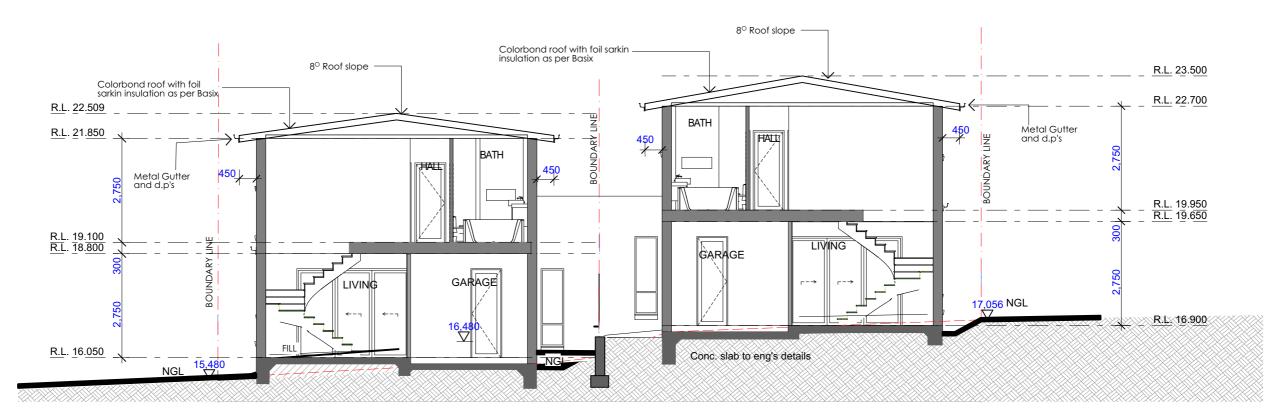





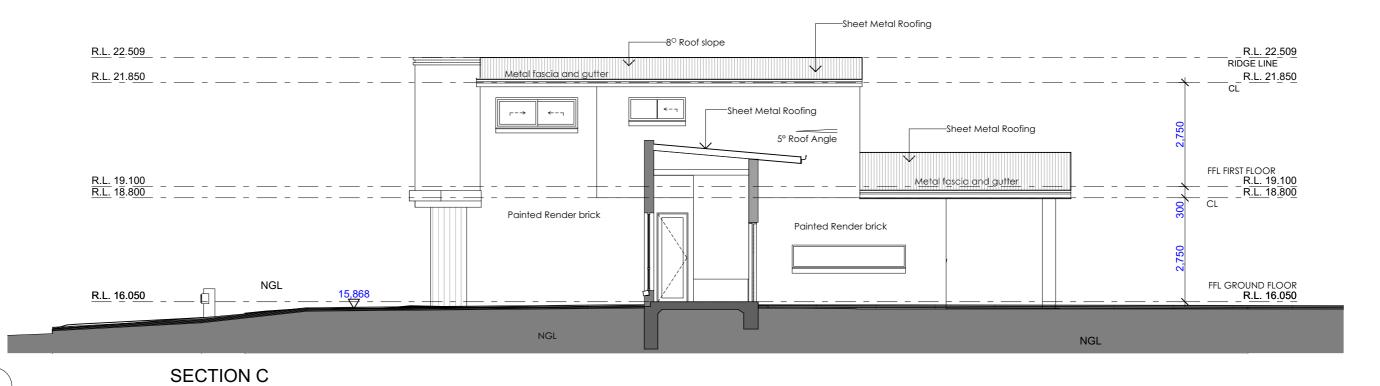

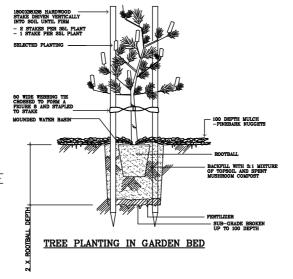TURF & GARDEN EDGE DETAIL



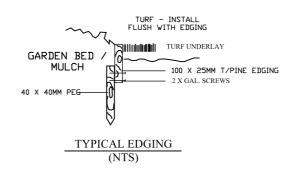

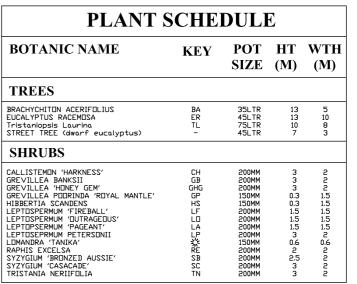

NOTES AND SPECIFICATIONS

EXCAVATIONS:

Any services drawn on the plans have been indicatively located. Prior to carrying out any excavations, the contractor is to confirm the locations of all services. Service pits and lids are to be covered by any materials. Trim and grade area to form a smooth even finish.

The topsoil to all garden bed areas shall be 2 part site topsoil and 1 part organic compost thoroughly mixed

The topsoil to all garden bed areas shall be 2 part site topsoil and 1 part organic composit throughly mixed together prior to placing into position. Where site topsoil is not suitable improted topsoil meeting the requirements of AS4419-1998 shall be used. Garden bed sub grades are to be cultivated to a depth of 150mm. Topsoil depth of all garden bed areas in deep soil to be 300mm(min.) At the completion of all planting operations apply a 75mm layer mulch over entire garden bed / planter taking care not to smother plants. Reduce depth of mulch around base of plants to form "watering dish". Mulch to be Pin Bark Nuggets as supplied by ANI or similar. Mulch used in garden beds located within an onsite detention basin shall be 75mm layer mineral mulch such as scona gravel.

TURF:
Apply 150 layer of topsoil to all turfed areas laid over deep soil. Prior to laying turf, contractor to ensure all top soiled areas are smoothly graded with no surface depressions or other irregulanties, large stones or building debris. The surface is to have even running falls to all drainage points. Turf used for this pite shall be cultivated Kituyu, Unless specified otherwise, burf shall be laid flush with adjacent finished surface levels. Water turfed areas immediately after turfing operations. Top dress any excessively undulating areas to form a smooth level surface with a coarse grade washed river sand.

All garden edging as denoted by "GE" on the plan is to be constructed using either insitu concrete or brick laid over 1 00mm layer mortar. Extruded bricks shall not be used. (Refer to detail).

All plant maternal are to be the number species variety and size as specified on the plant schedule. The plants are to be healthy nursery stock, free from disease, insects all weed or roots of weeds. No plant is to be installed which has not been hardened off or is otherwise inferior in quality. All plants are to be thoroughly soaked I hour prior to planting.

All tree planting holes to be excavated 200mm wider and at least 200mm deeper than the root ball size (container size). All trees are to be staked with $2 \times 50 \times 50 \times 2400$ HW stack. Secure tree to stake using 50mm jute webbing tied in figure δ loop. Drive stakes into ground well clear of root ball. Where trees are turfed areas, ensue a 75mm layer of mulch is placed around the base of the tree to extent of the excavated area, reduce depth of mulch around stem to form watering dish.

SERVICES: Any services located in the landscape plans are indicative locations for general information only. Prior to excavation contractor to confirm location of all services including any sewer lines. Where the proposed tree located above any existing sewer line. Contractor to notify the landscape architect to relocate tree.

Provide one hose cock in the front and rear landscape areas of each dwelling

All pavement areas including driveways and pathways are to have a stenciled concrete finish. All pavement surfaces to comply with requirements of AS/NZ 3661.1 1993. Slip Resistance of Pedestrian Surface.

All materials and standards of workmanship used on this project is to comply with the latest revision of the relevant Australian Standards.

MAINTENANCE:

Maintain all landscape areas to ensure plant health and occupant safety for a period of 12 month beginning from date of practical completion to the satisfaction of Council. Maintenance will include but is not limited to the following activities: Mowing, Edging and Top dressing of turf areas, Weeding garden beds and turf areas. (All trees will require regular ongoing observation and maintenance).

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Should there be any discrepancies on the drawings and or on site, landscape contractor to notify the Superintendent for resolution prior to the commencement of the works. Where the situation is not readily resolved onsite, the Superintendent is to notify the landscape architect immediately for correction.

LANDSCAPE DESIGN NOTES:

THE LANDSCAPING OF THE SITE SHALL BE CARRIED OUT IN ACCORDANCE WITH THE APPROVED PLANS.

ALL LANDSCAPING WORKS CARRIED OUT, PRIOR TO THE ISSUE OF AN OCCUPATION CERTIFICATE, IN ACCORDANCE WITH THE APPROVED C.C. PLANS. THE LANDSCAPING IS TO BE MAINTAINED TO THE APPROVED STANDARD AT ALL

EXISTING SITE TREES SHALL BE REMOVED IN ACCORDANCE WITH THE APPROVED LANDSCAPE PLAN.

LANDSCAPE PLAN 1:200

THIS DRAFTING HAS BEEN PRODUCED TO SHOW DESIGN INTENT ONLY. ALL DIMENSIONS MUST BE VERIFIED ON SITE.THE BUILDER SHALL CHECK AND VERIFY ALL DIMENSIONS AND ALL ERRORS AND OMISSIONS TO THE DESIGNER/DRAFTER. DO NOT SCALE THE DRAWINGS. DRAWINGS SHALL NOT BE USED FOR CONSTRUCTION PURPOSES UNTIL ISSUED BY THE DESIGNER FOR CONSTRUCTION. ALL PRICING MUST ALLOWED FOR ALL ITEMS SPECIFIED. DO NOT SCALE FROM DRAWING. ANY VARIATIONS TO SPECIFICATIONS AND DRAFTINGS MUST BE AUTHORISED BY THE CLIENT. COPYRIGHT OF THESE DESIGNS. DRAFTINGS AND SPECIFICATIONS ARE COPYRIGHT AND ARE THE PROPERTY OF AKTREUM BUILDING DESIGNERS. THEY MUST NOT BE USED, REPRODUCED OR COPIED WHOLLY OR IN PART WITHOUT THE WRITTEN PERMISSON OF THE OWNERS. THE USE OF THESE DRAWINGS ARE UNDER ALL CONDITION LISED ABOVE CONTACT ADAM NASSER 0435237853





PROPOSED ATTACHED DUAL

OCCUPANCY AMENDED DA CLAUSE 4.55 Sheet Title: CONCEPT LANDSCAPE PLAN

Client Mr HAYDAR ALI

11 HARDEN CRES GEORGES HALL LOT 22 DP236764

1:200 Drawing No.

05/01/25

Sheet Number: 24

Date/Revision

Quality of Work: All work carried out must comply with: Building Code of Australia to the extent required under Environmental Planning Assessment Act 1979, all other relevant codes, standards and specifications that the work is required to comply with under any law and the conditions of any relevant development consent or complying development certificate and any construction certificate. **Window List** W02 W03 W04 W05 W06 W07 W08 W09 W10 W11 W12 W13 W16 ID W14 W x H Size 1,200×2,050 1,500×1,200 900×1,900 900×1,900 1,500×1,200 3,000×600 3,000×600 1,500×1,450 900×1,900 900×1,900 1,500×1,450 2,170×800 750×2,050 600×2,050 600×2 **3D Front View** W17 W18 W19 W22 W23 W24 W25 W26 W27 W29 ID W20 W21 W28 2,050 W x H Size 2,170×800 1,400×2,104 2,170×800 700×900 2,000×800 1,500×600 2,170×800 2,170×800 1,500×600 2,000×800 700×900 2,170×800 1,400×2 **3D Front View** WINDOW SCHEDULE Door List ID D01 D02 D03 D04 D05 D005 D06 D006 D006 D07 D007 D08 D008 D09 W x H Size 1,200×2,350 3,000×2,350 820×2,100 3,000×2,350 720×2,350 1,200×2,350 820×2,100 2,100×2,350 820×2,100 2,100×2,350 820×2,100 2,400×2,100 820×2,100 720×2,100 3D Front View ID D10 GD02 GD03 W x H Size 2,400×2,100 2,700×2,400 2,755×2,340 3D Front View DOOR SCHEDULE NI THIS DRAFTING HAS BEEN PRODUCED TO SHOW DESIGN INTENT ONLY. ALL DIMENSIONS MUST BE VERIFIED ON SITE.THE BUILDER SHALL CHECK AND VERIFY ALL DIMENSIONS AND ALL ERRORS AND OMISSIONS TO THE PROPOSED ATTACHED DUAL DESIGNER/DRAFTER. DO NOT SCALE THE DRAWINGS. DRAWINGS SHALL NOT BE USED FOR CONSTRUCTION OCCUPANCY AMENDED DA CLAUSE 4.55 Sheet Title: WINDOWS AND DOORS SCHEDULE PURPOSES UNTIL ISSUED BY THE DESIGNER FOR CONSTRUCTION. ALL PRICING MUST ALLOWED FOR ALL ITEMS SPECIFIED, DO NOT SCALE FROM DRAWING, ANY VARIATIONS TO SPECIFICATIONS AND DRAFTINGS MUST BE Date/Revision Client AUTHORISED BY THE CLIENT. COPYRIGHT OF THESE DESIGNS. DRAFTINGS AND SPECIFICATIONS ARE COPYRIGHT AND 1:1 05/01/25 ARE THE PROPERTY OF AKTREUM BUILDING DESIGNERS. THEY MUST NOT BE USED, REPRODUCED OR COPIED WHOLLY OR 11 HARDEN CRES GEORGES Mr HAYDAR ALI Sheet Number: 25 IN PART WITHOUT THE WRITTEN PERMISSON OF THE OWNERS. THE USE OF THESE DRAWINGS ARE UNDER ALL CONDITIONS Drawing No.

USED ABOVE, CONTACT ADAM NASSER 0435237853

HALL LOT 22 DP236764

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	SUMMARY OF BAS	IX COMMITMENTS		
Basix Certificate Number: 1781102M - Unit 1				
Certificate Prepared	Ву:			
	Name/Company Name: G	Green Choice Consulting		
	ABN: 6365	58893415		
	WATER COM	MITMENTS		
Landscape				
Are	ea of Garden & Lawn (m²)	50.00		
Area of Indige	enous or low water use species (m²)	0.00		
Fixtures				
	Showerheads	4 star (> 4.5 but <= 6 L/	min)	
	Toilet	6 star		
	Kitchen Taps	6 star		
	Bathroom Taps	6 star		
Alternative Water				
	Rainwater Tank (L)	2000.00		
	ected from Roof Area (m²)	135.00		
Tank Connected To				
Toilets		No		
	Laundry	No		
	Private Landscape	Yes		
	Private Swimming Pool	N/A		
	Private Outdoor Spa	N/A		
	ENERGY COI	MMITMENTS		
Hot Water System	gas instantaneous	5 star		
Cooling	Living	1-phase airconditioning - non ducted	2.5 star	
	Bedroom	1-phase airconditioning - non ducted	2.5 star	
Heating	Living	1-phase airconditioning - non ducted	2.5 star	
	Bedroom	1-phase airconditioning - non ducted	2.5 star	
	Bathroom Exhaust	individual fan, ducted to façade or roof	manual switch on/off	
Ventilation	Kitchen Exhaust	individual fan, ducted to façade or roof	manual switch on/off	
	Laundry Exhaust	individual fan, ducted to façade or roof	manual switch on/off	
Natural Lighting	Skylight or Window in Kitchen	yes		
	Skylight or Window in Bathrooms/Toilets	2		
Alternative Energy	N/A			
	OTHER COM			
	Cooktop/Oven	gas cooktop & electric o	oven	
	Outdoor Clothes line	yes		
	Indoor Clothes line	no		

	SUMMARY OF BAS	SIX COMMITMENTS			
	Basix Certificate Num	ber: 1781102M - Unit 2			
Certificate Prepared I	<u> </u>				
Name/Company Name: Green Choice Consulting					
		558893415			
	WATER CO	MMITMENTS			
Landscape					
Are	ea of Garden & Lawn (m²)	50.00			
Area of Indige	enous or low water use species (m²)	0.00			
Fixtures					
	Showerheads	4 star (> 4.5 but <= 6 L/	/min)		
	Toilet	6 star			
	Kitchen Taps	6 star			
	Bathroom Taps	6 star			
Alternative Water					
	Rainwater Tank (L)	2000.00			
	ected from Roof Area (m²)	135.00			
Tank Connected To					
Toilets		No			
	Laundry	No			
	Private Landscape	Yes			
F	Private Swimming Pool	N/A			
	Private Outdoor Spa	N/A			
	ENERGY CO	MMITMENTS			
Hot Water System	gas instantaneous	5 star			
Cooling	Living	1-phase airconditioning - non ducted	2.5 star		
Cooling	Bedroom	1-phase airconditioning - non ducted	2.5 star		
Heating	Living	1-phase airconditioning - non ducted	2.5 star		
rieating	Bedroom	1-phase airconditioning - non ducted	2.5 star		
	Bathroom Exhaust	individual fan, ducted to façade or roof	manual switch on/o		
Ventilation	Kitchen Exhaust	individual fan, ducted to façade or roof	manual switch on/o		
	Laundry Exhaust	individual fan, ducted to façade or roof	manual switch on/o		
Natural Lighting	Skylight or Window in Kitchen	yes			
Natural Lighting	Skylight or Window in Bathrooms/Toilets	2			
Alternative Energy	N/A				
	OTHER CO	MMITMENTS			
	Cooktop/Oven	gas cooktop & electric	oven		
	Outdoor Clothes line	yes			
	Indoor Clothes line	no			

NCC COMPLIANCE

Works must comply with NCC 2022 (sheets 3 & 6 references the NCC 2019)

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Client

Mr HAYDAR ALI

PROPOSED ATTACHED DUAL

OCCUPANCY AMENDED DA CLAUSE 4.55 Sheet Title: BASIX COMMITMENTS

11 HARDEN CRES GEORGES

HALL LOT 22 DP236764

Date/Revision 1:1

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Sheet Number: 26

Quality of Work: All work carried out must comply with: Building Code of Australia to the extent required under Environmental Planning Assessment Act 1979, all other relevant codes, standards and specifications that the work is required to comply with under any law and the conditions of any relevant development consent or complying development certificate and any construction certificate.



STREETSCAPE HARDEN CRESCENT
1:150

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PROPOSED ATTACHED DUAL

OCCUPANCY AMENDED DA CLAUSE 4.55 Sheet Title: STREETSCAPE & FENCE DETAIL

Mr HAYDAR ALI

11 HARDEN CRES GEORGES
HALL LOT 22 DP236764


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Drawing No.:

awing No.: Sheet Number: 27

05/01/25

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SHADOW DIAGRAMS 21 JUNE 1:200

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PROPOSED ATTACHED DUAL OCCUPANCY AMENDED DA CLAUSE 4.55 Sheet Title: SHADOW DIAGRAMS

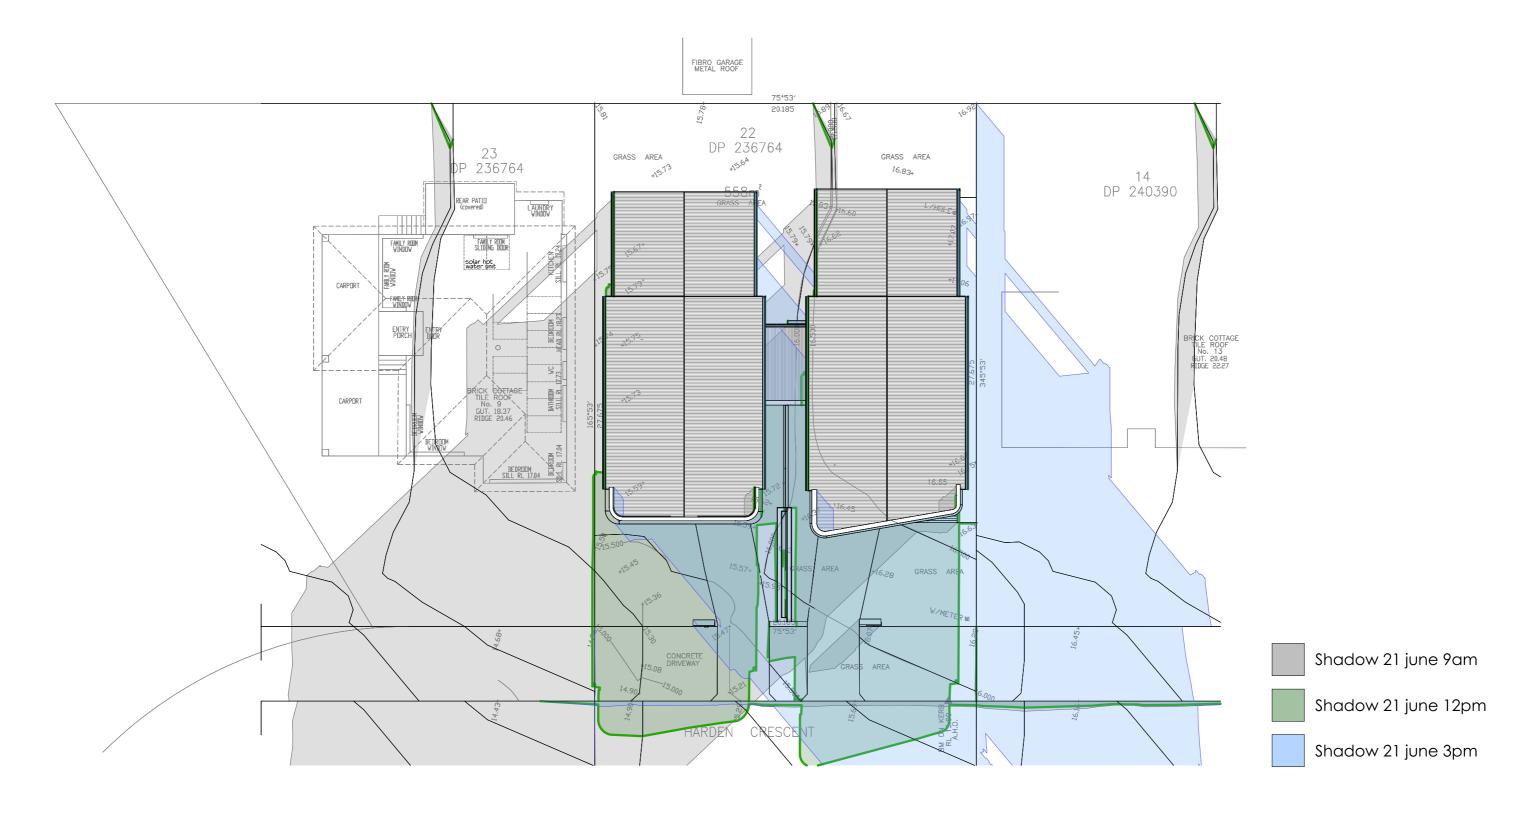Mr HAYDAR ALI

Mr HAYDAR ALI

11 HARDEN CRES GEORGES
HALL LOT 22 DP236764